

LOCATION MAP

PHOTO OF PROJECT

PROJECT INFORMATION	PROJECT DESCRIPTION	PROJECT TEAM		
LOT ADDRESS: 27 Brock St. Penetanguishene, ON L9M 1R9	SCOPE OF WORK: SPLIT BASEMENT AND MAIN FLOOR INTO TWO SEPARATE UNITS, UPSTAIRS UNIT UNCHANGED	OWNER:		CAMERON JACKSON
LOT SIZE: 8,272.74 SQFT			PHONE EMAIL ADDRESS	289-380-3483 CAMERONJJACKSON@HOTMAIL.CA 27 BROCK ST. PENETANGUISHENE, ON L9M 1R9
		ARCHITECTURAL DESIGNER:		JUSTIN SIMPSON
ZONING: R1			PHONE EMAIL ADDRESS	905-806-3533 INFO@SIMPSONARCHITECTURE.CA 22701 CATERING RD. QUEENSVILLE ON. LOG 1R0
PROPOSED GROSS SQUARE FOOTAGE: 1595 SQFT				

# PROJECT NOTES

### PROJECT NOT

**LEGEND** 

Wall Type (see wall type schedule)

Window Type (see window schedule)

Door Type (see door schedule)


**Building Elevation** 


Elevation Mark

**Revision Tag** 

Room Name / Number

- 1. ALL CONSTRUCTION WORK SHALL BE DONE IN ACCORDANCE WITH ALL APPLICABLE BUILDING CODES AND ORDINANCES OR AGENCIES HAVING JURISDICTION OVER THIS PROJECT.
- 2. ESTABLISH AND MAINTAIN PROJECT SAFETY DURING CONSTRUCTION TO PROTECT PERSONNEL, TENANTS, AND BUILDING OCCUPANTS.
- 3. THE GENERAL CONTRACTOR SHALL ARRANGE ALL INSPECTIONS AND TESTS AS SPECIFIED OR REQUIRED BY THE BUILDING DEPARTMENT AND SHALL PAY ALL COSTS AND FEES FOR SAME. THE CONTRACTOR SHALL SECURE ALL BUILDING PERMITS AND UPON COMPLETION OF THE PROJECT (PRIOR TO FINAL PAYMENT) DELIVER TO THE OWNER A CERTIFICATE OF OCCUPANCY OR USE FROM THE BUILDING DEPARTMENT.
- 4. ALL PLUMBING AND ELECTRICAL WORK SHALL BE PERFORMED BY LICENSED CONTRACTORS. CONTRACTORS SHALL SUBMIT ALL REQUIRED PERMITS, CERTIFICATES, AND SIGN-OFFS TO OWNER
- 5. THE GENERAL CONTRACTOR SHALL VERIFY ALL DIMENSIONS, BE FAMILIAR WITH THE EXISTING CONDITIONS, AND BRING ANY DISCREPANCIES TO THE ATTENTION OF THE DESIGNER PRIOR TO SUBMISSION OF CONSTRUCTION PROPOSAL AND BEFORE COMMENCEMENT OF THE WORK. THE DRAWINGS REFLECT CONDITIONS REASONABLY INFERRED FROM THE EXISTING VISIBLE CONDITIONS BUT CANNOT GUARANTEED BY THE DESIGNER. DRAWINGS MAY NOT BE SCALED. VERIFY ALL DIMENSIONS IN THE FIELD.
- 6. CONTRACTOR SHALL FIELD VERIFY ALL MEASUREMENTS, LOCATIONS, AND CHARACTERISTICS OF ALL WORK AND EQUIPMENT (WHETHER SUPPLIED BY THE OWNER OR OTHERS) WITH THE SUPPLIER OR MANUFACTURER PRIOR TO THE START OF RELATED WORK.
- 7. THE GENERAL CONTRACTOR SHALL LAY OUT ALL WORK AND BE RESPONSIBLE FOR ALL DIMENSIONS AND CONDITIONS FOR TRADES SUCH AS ELECTRICAL, PLUMBING, ETC.
- 8. THE GENERAL CONTRACTOR/CONSTRUCTION MANAGER SHALL PROVIDE AND MAINTAIN ACCESS TO THE PREMISES AT ALL TIMES.
- 9. THE GENERAL CONTRACTOR SHALL KEEP THE CONSTRUCTION SITE FREE AND CLEAR OF ALL DEBRIS AND KEEP OUT ALL UNAUTHORIZED PERSONS. UPON COMPLETION OF WORK, THE ENTIRE CONSTRUCTION AREA IS TO BE THOROUGHLY CLEANED AND PREPARED FOR OCCUPANCY BY OWNER. ALL MATERIALS AND DEBRIS RESULTING FROM THE CONTRACTOR'S WORK SHALL BE REMOVED FROM THE SITE AND DISPOSED OF PROPERLY. CARE SHALL BE TAKEN DURING CONSTRUCTION THAT NO DEBRIS OR MATERIALS ARE DEPOSITED IN ANY RIGHT OF WAY AREA.
- 10. THE GENERAL CONTRACTOR SHALL BE RESPONSIBLE FOR PROTECTING ALL EXISTING AND NEW CONDITIONS AND MATERIALS ON THE SITE. ANY DAMAGE CAUSED BY OR DURING THE EXECUTION OF THE WORK IS THE CONTRACTOR'S RESPONSIBILITY AND SHALL BE REPAIRED TO THE OWNER'S SATISFACTION AT THE CONTRACTOR'S EXPENSE.
- 11. ANY VARIATIONS FROM INDICATED DIMENSIONS OR CONDITIONS SHALL BE BROUGHT TO THE IMMEDIATE ATTENTION OF THE DESIGNER.
- 12. NO CHANGES ARE TO BE MADE WITHOUT THE APPROVAL OF THE DESIGNER.
- 13. NO CUTTING OR DAMAGE TO BUILDING STRUCTURAL COMPONENTS WILL BE ALLOWED WITHOUT WRITTEN AUTHORIZATION FROM THE DESIGNER.
- 14. PROVIDE BRACING, BLOCKING, AND/OR STRUCTURE AS REQUIRED TO FACILITATE INSTALLATION OF ALL WALL AND MILLWORK MOUNTED EQUIPMENT, IN NEW AND EXISTING WALLS. THE CONTRACTOR SHALL BE RESPONSIBLE FOR DETERMINING THE SUPPORT REQUIRED TO MAINTAIN THE INTEGRITY OF THE WALLS AND THE SECURITY OF THE EQUIPMENT.
- 15. ALL WOOD BLOCKING SHALL BE FIRE RETARDANT TREATED. PROVIDE WOOD BLOCKING IN ALL STUD WALLS AT MILLWORK AND SPECIAL ITEM ANCHORING POINTS. WOOD BLOCKING SHALL BE MOISTURE TREATED IF LOCATED IN DAMP LOCATIONS OR ADJACENT TO CONCRETE OR MASONRY CONSTRUCTION. IF WOOD BLOCKING IS NOT PERMITTED BY CODE, THEN METAL STRIPS SHALL BE USED.
- 16. THE CONTRACTOR IS RESPONSIBLE FOR FIELD DIMENSIONS OF ALL MILLWORK, GLASS, DOOR OPENINGS, AND OTHER STRUCTURES PRIOR TO COMMENCEMENT OF FABRICATION.
- 17. ALL WORK SHALL CONFORM IN QUALITY TO ACCEPTED INDUSTRY STANDARDS. ALL MILLWORK SHALL CONFORM TO A.W.I. PREMIUM GRADE STANDARDS, UNLESS OTHERWISE NOTED.
- 18. THE MATERIALS USED FOR CONSTRUCTION OF SPACE SHALL NOT CONTAIN ASBESTOS, P.C.B, OR ANY OTHER HAZARDOUS MATERIALS OF ANY TYPE. MANUFACTURERS' NAMES AND TRADEMARKS SHALL NOT BE PROMINENTLY VISIBLE TO THE PUBLIC.
- 19. ALL WALLS TO BE LAID OUT AT 90-DEGREE ANGLES UNLESS OTHERWISE NOTED.
- 20. THE SCOPE OF WORK OF ALL TRADES IS TO INCLUDE ALL MATERIALS AND LABOR REQUIRED TO TOTALLY COMPLETE THE PROJECT AND BE FUNCTIONALLY CONSISTENT WITH THE DESIGN INTENT AS EXPRESSED IN THE CONSTRUCTION DOCUMENTS.
- 21. ALL UTILITIES SHALL BE CONNECTED TO PROVIDE GAS, ELECTRIC, AND WATER TO ALL EQUIPMENT WHETHER SAID EQUIPMENT IS IN CONTRACT OR NOT. EQUIPMENT SHALL BE GUARANTEED TO FUNCTION PROPERLY UPON COMPLETION.
- 22. MANUFACTURER'S STANDARD SPECIFICATIONS AND MATERIALS APPROVED FOR PROJECT USE ARE HEREBY MADE PART OF THESE NOTES WITH SAME FORCE AND EFFECT AS IF WRITTEN OUT IN FULL HEREIN. ALL APPLIANCES, FIXTURES, EQUIPMENT, HARDWARE, ETC. SHALL BE INSTALLED IN ACCORDANCE WITH MANUFACTURER'S SPECIFICATIONS AND PROCEDURES.
- 23. THERMOSTATS SHALL NOT BE LOCATED IN THE CENTER OF A WALL, ON AN ACCENT/SPECIALTY WALL, OR IN A LOCATION WHICH CONFLICTS WITH FURNISHINGS WITHOUT THE DESIGNER'S APPROVAL.
- 24. WRITTEN WORDS TAKE PRECEDENCE OVER DRAWN LINES. LARGE-SCALE DETAILS AND PLANS TAKE PRECEDENCE OVER SMALLER DETAILS AND PLANS. SHOULD A CONFLICT ARRIVE BETWEEN THE SPECIFICATIONS AND DRAWINGS, THE REQUIREMENTS DEEMED MOST STRINGENT SHALL BE USED.
- 25. MINOR DETAILS NOT USUALLY SHOWN OR SPECIFIED BUT NECESSARY FOR PROPER AND ACCEPTABLE CONSTRUCTION, INSTALLATION, OR OPERATION OF ANY PART OF THE WORK AS DETERMINED BY THE ARCHITECT SHALL BE INCLUDED IN THE WORK AS IF IT WERE SPECIFIED OR INDICATED ON THE DRAWINGS.
- 26. ALL ARCHITECTURAL DRAWINGS AND CONSTRUCTION NOTES ARE COMPLIMENTARY. WHAT IS INDICATED AND CALLED FOR BY ONE SHALL BE BINDING AS THOUGH CALLED FOR BY ALL. NO DEVIATION FROM THE DRAWINGS OR SPECIFICATIONS OR INTENT OF SAME SHALL BE MADE WITHOUT THE DESIGNER'S WRITTEN AUTHORIZATION.
- 27. ALL WORK SHALL BE GUARANTEED FOR ONE YEAR AFTER FINAL APPROVAL. THE GENERAL CONTRACTOR SHALL SIGN THE WRITTEN GUARANTEE AS PROVIDED BY THE OWNER. THE GUARANTEE BY
- 28. ALL DIMENSIONS ARE TO FACE OF STUD OR CENTERLINE OF STRUCTURE UNLESS OTHERWISE NOTED.
- 29. DOOR AND WINDOW DETAILS ARE INDICATED ON THE DOOR AND WINDOW SCHEDULES. DOOR AND WINDOW DIMENSIONS ARE TO CENTERLINES OF UNITS UNLESS OTHERWISE NOTED.

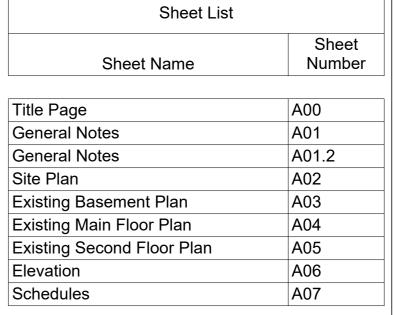

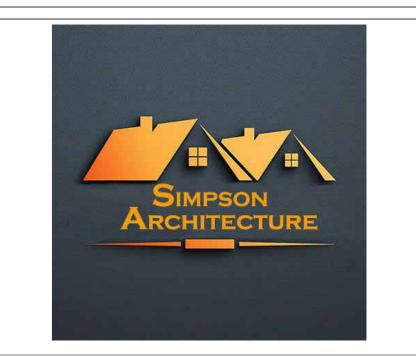

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1. ALL DRAWINGS AND SPECIFICATIONS PROVIDED HEREIN ARE CONSIDERED PROPRIETARY DOCUMENTS CREATED BY SIMPSON ARCHITECTURE. THESE MATERIALS ARE SAFEGUARDED UNDER INTELLECTUAL PROPERTY RIGHTS AND MAY NOT BE REPLICATED, DISSEMINATED, MODIFIED, OR SUBMITTED FOR APPROVAL WITHOUT OBTAINING EXPLICIT WRITTEN CONSENT FROM SIMPSON ARCHITECTURE. UNAUTHORIZED USE, DISTRIBUTION, OR ALTERATION OF THESE MATERIALS IS STRICTLY PROHIBITED.

2. ONLY VERIFIED FINAL DRAWINGS BEARING THE STAMP "FOR CONSTRUCTION PURPOSE" SHALL BE USED ON THE JOB SITE. DRAWINGS WITHOUT THE STAMP ARE CONSIDERED PRELIMINARY DRAWINGS ONLY.

3. ALL WORK INHERENT TO THIS PROJECT SHALL BE PERFORMED ACCORDING TO THE ONTARIO BUILDING CODE

4. THE CONTRACTOR IS RESPONSIBLE FOR VERIFYING ALL LEVELS & DIMENSIONS, ANY DISCREPANCIES ARE TO BE REPORTED TO SIMPSON ARCHITECTURE BEFORE COMMENCING THE WORK.

5.NO MODIFICATION OF THE PLANS SHALL BE DONE WITHOUT THE WRITTEN APPROVAL OF SIMPSON ARCHITECTURE.

6. DIMENSIONS ON DRAWINGS SHALL GOVERN OVER SCALE.

7. THE CONTRACTOR SHALL BE RESPONSIBLE FOR ANY DEVIATIONS FROM THE ORIGINAL DRAWINGS, IF NOT AUTHORIZED WITH A WRITTEN CHANGE ORDER BY SIMPSON ARCHITECTURE

SIMPSON ARCHITECTURE

The undersigned has reviewed and takes responsibility for this design, and has the qualifications and meets the requirements set out in the Ontario Building Code to be a designer

QUALIFICATION INFORMATION

Required unless the design is exempt under 2.17.5.1. of the Building Code

Justin Simpson

Justin Simpson

SIGNATURE

REGISTRATION INFORMATION

Required unless the design is exempt under 2.17.5.1. of the Building Code

REGISTRATION INFORMATION

Required unless the design is exempt under 2.17.5.1. of the Building Code

Justin Simpson O/A Simpson Architecture

FIRM NAME

No.	Description	Da

### The Jackson's

27 Brock St.
Penetanguishene, ON L9M
1R9

## Title Page

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	Project Number	25-009
	Issued For Permit Date	25-07-03
	Drawn By	Justin Simpson
	BCIN#	123605

Scale

A00

1/4" = 1

#### **EXCAVATION AND BACKFILL**

\*EXCAVATION SHALL BE UNDERTAKEN IN SUCH A MANNER SO AS TO PREVENT DAMAGE TO EXISTING STRUCTURES, ADJACENT PROPERTY AND UTILITIES

\*THE TOPSOIL AND VEGETABLE MATTER IN UNEXCAVATED AREAS UNDER A BUILDING SHALL BE REMOVED. THE BOTTOM OF EXCAVATIONS FOR FOUNDATIONS

SHALL BE FREE OF ALL ORGANIC MATERIAL

\*IF TERMITES ARE KNOWN TO EXIST, ALL STUMPS, ROOTS AND WOOD DEBRIS SHALL BE REMOVED TO A MINIMUM DEPTH OF 300mm IN EXCAVATED AREAS

UNDER A BUILDING, AND THE CLEARANCE BETWEEN UNTREATED STRUCTURAL WOOD ELEMENTS AND THE GROUND SHALL BE NO LESS THAN 450mm

\*BACKFILL WITHIN 600mm OF THE FOUNDATION WALLS SHALL BE FREE OF DELETERIOUS DEBRIS AND BOULDERS OVER 250mm IN DIAMETER

#### DAMP PROOFING AND DRAINAGE

\*IN NORMAL SOIL CONDITIONS . THE EXTERIOR SURFACES OF FOUNDATION WALLS ENCLOSING BASEMENTS AND CRAWL SPACES SHALL BE DAMP PROOFED.

WHERE HYDROSTATIC PRESSURE OCCURS, A WATERPROOFING SYSTEM IS REQUIRED

\*MASONRY FOUNDATION WALLS SHALL BE PARGED WITH 6mm OF MORTAR COVERED OVER THE FOOTING PRIOR TO DAMP PROOFING

\*100mm DIA. FOUNDATION DRAINS SHALL BE LAID ON LEVEL, UNDISTURBED GROUND ADJACENT TO THE FOOTINGS AT OR BELOW THE TOP OF THE

BASEMENT SLAB OR CRAWL SPACE FLOOR, AND SHALL BE COVERED WITH 150mm OF CRUSHED STONE, FOUNDATION DRAINS SHALL DRAIN TO A DRAINAGE

DITCH, DRY WELL OR SUMP

\*WINDOW WELLS SHALL BE DRAINED TO THE FOOTING LEVEL OR TO A DITCH OR SUMP PUMP

\*DOWNSPOUTS SHALL HAVE EXTENSIONS TO CARRY WATER AWAY FROM THE BUILDING AND PROVISIONS SHALL BE MADE TO PREVENT SOIL EROSION

\*CONCRETE SLABS IN ATTACHED GARAGES SHALL BE SLOPED TO DRAIN TO THE EXTERIOR

\*THE BUILDING SITE SHALL BE GRADED SO THAT SURFACE, SUMP, AND ROOF DRAINAGE WILL NOT ACCUMULATE AT OR NEAR THE BUILDING AND WILL NOT ADVERSELY AFFECT ADJACENT PROPERTIES

### **FOOTINGS**

\*MINIMUM 15MPA POURED CONCRETE

\*MINIMUM 1200mm BELOW FINISHED GRADE

\*FOOTINGS SHALL BE FOUNDED ON NATURAL UNDISTURBED SOIL, ROCK OR COMPACTED GRANULAR FILL WITH MINIMUM BEARING CAPACITY OF 75KPA.

100KPA FOR ICF

#### **FOOTING SIZE**

FLOORS SUPPORTING SUPPORTING COLUMN

SUPPORTED EXT. WALL INT. WALL AREA 0.40m2 250mm 200mm 0.75m2 350mm 350mm 500mm 1.00m2 450mm

\*INCREASE EXTERIOR FOOTING WIDTH BY 65mm FOR EACH STOREY OF BRICK VENEER SUPPORTED BY 130mm FOR EACH STOREY OF MASONRY AND BY

150mm FOR ICF

\*INCREASE INTERIOR FOOTING WIDTH BY 100mm FOR EACH STOREY OF MASONRY ABOVE FOOTING AND BY 100mm FOR EACH 2700mm OF WALL HEIGHT ABOVE 5500mm

\*THE PROJECTION OF AN UNREINFORCED FOOTING BEYOND THE WALL SUPPORTED SHALL NOT BE GREATER THAN ITS **THICKNESS** 

### STEP FOOTINGS

STEP FOOTINGS: HORIZONTAL STEP = 600mm (23 5/8") MIN. VERTICAL STEP = 600mm (23 5/8") MAX, FOR FIRM SOILS, 400mm FOR SAND & GRAVEL.

CONCRETE STRENGTH AT 28 DAYS MIN 25MPA ALLOW FULL 48HRS FOR CONCRETE TO CURE PRIOR TO GROUTING AND PROCEEDING TO THE ALTERNATING

NEXT STAGE

SHORE AND BRACE WHERE NECESSARY TO ENSURE THE SAFETY AND STABILITY OF BOTH EXISTING STRUCTURES DURING UNDERPINNING

### **FOUNDATION WALLS**

\*TO BE POURED CONCRETE, UNIT MASONRY, ICF OR PRESERVED WOOD (SEE DRAWINGS FOR TYPE AND THICKNESS) \*DAMP PROOFING SHALL BE A HEAVY COAT OF BITUMINOUS MATERIAL

\*FOUNDATION WALL TO EXTEND MINIMUM 150mm ABOVE FINISHED GRADE

\*A DRAINAGE LAYER IS REQUIRED ON THE OUTSIDE OF A FOUNDATION WALL WHERE THE INTERIOR INSULATION EXTENDS MORE THAN 900mm BELOW

EXTERIOR GRADE. A DRAINAGE LAYER SHALL CONSIST OF

-MIN. 19mm MINERAL FIBRE INSULATION WITH MIN. DENSITY OF 57KG/m3

-MIN. 100mm OF FREE DRAINAGE GRANULAR MATERIAL, OR

-AN APPROVED SYSTEM WHICH PROVIDES EQUIVALENT PERFORMANCE

\*FOUNDATION WALLS SHALL BE BRACED OR HAVE THE FLOOR JOISTS INSTALLED BEFORE BACKFILLING

## **CONCRETE FLOOR SLABS**

\*GARAGE, CARPORT AND EXTERIOR SLABS AND EXTERIOR STEPS SHALL BE 32MPA CONCRETE WITH 5-8% AIR ENTRAINMENT \*BASEMENT SLAB 25MPA CONCRETE, MINIMUM 75mm THICK, PLACED ON A MINIMUM 100mm OF COARSE, CLEAN, GRANULAR MATERIAL

\*ALL FILL OTHER THAN COARSE. CLEAN MATERIAL PLACED BENEATH CONCRETE SLABS SHALL BE COMPACTED TO PROVIDE UNIFORM SUPPORT

### **MASONRY WALLS**

\*WHERE CONSTRUCTED OF 90mm BRICK, WALL SHALL BE BONDED WITH A HEADER COURSE EVERY 600mm O/C VERTICALLY AND HORIZONTALLY AND 900mm

O/C FOR BLOCK OR TILE

\*PROVIDE 50mm SOLID MASONRY, CONCRETE FILLED TOP COURSE OR CONTINUOUS 38X89 WOOD PLATE UNDER ALL ROOF AND FLOOR FRAMING MEMBERS

\*PROVIDE 190mm SOLID MASONRY UNDER BEAMS AND COLUMNS

\*MASONRY WALL TO BE TIED TO EACH TIER OF JOISTS WITH 40mm X 4.76mm CORROSION RESISTANT STEEL STRAPS, KEYED MINIMUM 100mm INTO

MASONRY. WHEN JOISTS ARE PARALLEL TO WALL, TIES ARE TO EXTEND ACROSS AT LEAST 3 JOISTS @ 2000mm O.C.

\*INSIDE OF WALL TO BE PARGED AND COVERED WITH NO. 15 BREATHER-TYPE ASPHALT PAPER \*FOR REDUCED FOUNDATION WALLS TO ALLOW A BRICK FACING WHILE MAINTAINING LATERAL SUPPORT, TIE MINIMUM 90mm BRICK TO MINIMUM 90mm

BACKUP BLOCK WITH CORROSION RESISTANT TIES AT LEAST 17.8m2 IN CROSS SECTIONAL AREA, SPACED 200mm VERTICALLY AND 900mm HORIZONTALLY,

WITH JOINTS COMPLETELY FILLED WITH MORTAR

\*MASONRY OVER OPENINGS SHALL BE SUPPORTED ON CORROSION RESISTANT OR PRIME PAINTED STEEL LINTELS WITH A

MINIMUM OF 150mm END BEARING.

#### **MASONRY VENEER**

\*MINIMUM 70mm THICK IF JOINTS ARE NOT RAKED AND 90mm THICK IF JOINTS ARE RAKED

\*MINIMUM 25mm AIR SPACE TO SHEATHING

\*PROVIDE WEEP HOLES @ 800mm O.C. AT THE BOTTOM OF THE CAVITY AND OVER THE DOORS AND WINDOWS \*DIRECT DRAINAGE THROUGH WEEP HOLES WITH 0.5mm POLY FLASHING EXTENDING MINIMUM 150mm UP BEHIND THE SHEATHING PAPER

\*VENEER TIES MINIMUM 0.76mm THICK X 22mm WIDE CORROSION RESISTANT STRAPS SPACED @ 500mm

**VERTICALLY AND 600mmHORIZONTALLY** 

\*FASTEN TIES WITH CORROSION RESISTANT 3.18mm DIAMETER SCREWS OR SPIRAL NAILS WHICH PENETRATE AT LEAST 30mm INTO STUDS

#### **WOOD FRAME CONSTRUCTION**

\*ALL LUMBER SHALL BE SPRUCE-PINE-FIR NO. 1 & 2, AND SHALL BE IDENTIFIED BY A GRADE STAMP \*MAXIMUM MOISTURE CONTENT 19% AT TIME OF INSTALLATION

\*WOOD FRAMING MEMBERS WHICH ARE SUPPORTED ON CONCRETE IN DIRECT CONTACT WITH SOIL SHALL BE SEPARATED FROM THE CONCRETE WITH

0.05mm POLYETHYLENE OR TYPE 'S' ROLL ROOFING

WALLS

\*EXTERIOR WALLS SHALL CONSIST OF:

-CLADDING

-AIR BARRIER SYSTEM LAPPED 100mm AT JOINTS

-LUMBER, PLYWOOD, OSB OR GYPSUM SHEATHING

-38X140 STUDS @ 400mm O.C.

RSI PER TABLE PROVIDED -38X140 BOTTOM PLATE

-38X140 DOUBLE TOP PLATE

\*INTERIOR LOAD BEARING WALLS SHALL CONSIST OF:

-38X89 STUDS @ 400mm O.C.

-38X89 BOTTOM PLATE AND DOUBLE 38X89 TOP PLATE

-38X89 MID-GIRTHS IF NOT SHEATHED

-12.7mm GYPSUM BOARD SHEATHING

## **FLOORS**

\*SEE STRUCTURAL ENGINEERING DRAWINGS FOR FLOOR JOIST SIZE AND SPACING REQUIREMENTS

\*JOISTS TO HAVE MINIMUM 38mm OF END BEARING

\*JOISTS SHALL BEAR ON A SILL PLATE FIXED TO FOUNDATION WITH 12.7mm ANCHOR BOLTS @ 2400mm O.C \*HEADER JOISTS BETWEEN 1200mm AND 3200mm IN LENGTH SHALL BE SIZED BY CALCULATIONS

\*TRIMMER JOISTS SHALL BE DOUBLED WHEN SUPPORTED HEADER IS BETWEEN 800mm AND 2000mm, TRIMMER JOISTS

SHALL BE SIZED BY CALCULATIONS WHEN SUPPORTED HEADER EXCEEDS 2000mm.

\*38X38 CROSS BRIDGING REQUIRED NOT MORE THAN 2100MM FROM EACH SUPPORT AND FROM OTHER ROWS OF BRIDGING

\*JOISTS SHALL BE SUPPORTED ON JOISTS HANGERS AT ALL FLUSH BEAMS, TRIMMERS, AND HEADERS \*NON-LOAD BEARING PARTITIONS SHALL BE SUPPORTED ON A JOISTS OR ON BLOCKING BETWEEN JOISTS \*SEE STRUCTURAL ENGINEERING DRAWINGS FOR SUBFLOORING REQUIREMENTS

**ROOF AND CEILINGS** 

\*SEE STRUCTURAL ENGINEERING DRAWINGS FOR ROOF CONSTRUCTION SIZING AND SPACING REQUIREMENTS \*HIP AND VALLEY RAFTER SHALL BE 38mm DEEPER THAN COMMON RAFTERS

\*38X89 COLLAR TIES @ RAFTER SPACING WITH 19X89 CONTINUOUS BRACE AT MID SPAN IF COLLAR TIE **EXCEEDS 2400mm IN LENGTH** 

\*SEE STRUCTURAL DRAWINGS FOR ROOF SHEATHING REQUIREMENTS

## **NOTCHING & DRILLING OF TRUSSES, JOISTS, RAFTERS**

\*HOLES IN FLOOR, ROOF AND CEILING MEMBERS TO BE NOT LARGER THAN 1/4 THE ACTUAL DEPTH OF MEMBER AND NOT

LESS THAN 50mm FROM EDGES

\*NOTCHES IF FLOOR, ROOF AND CEILING MEMBERS TO BE LOCATED ON TOP OF THE MEMBER WITHIN 1/2 THE ACTUAL DEPTH FROM THE EDGE OF BEARING

AND NOT GREATER THAN 1/3 THE JOIST DEPTH

\*WALL STUDS MAY BE NOTCHED OR DRILLED PROVIDED THAT NO LESS THAN 2/3 THE DEPTH OF THE STUD REMAINS, IF LOAD BEARING AND 40mm IF NON -

LOAD BEARING \*ROOF TRUSS MEMBERS SHALL NOT BE NOTCHED, DRILLED OR WEAKENED UNLESS ACCOMMODATED IN THE DESIGN

\*Wall studs may be notched or drilled provided that no less than 2/3 the depth of the stud remains, if load bearing and 40mm if non - load bearing

\*Roof truss members shall not be notched, drilled or weakened unless accommodated in the design



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No.	Description	Date

## The Jackson's

27 Brock St. Penetanguishene, ON L9M

## **General Notes**

25-009 **Project Number** 25-07-03 **Issued For Permit Date** Justin Simpson Drawn By 123605 BCIN#

A01

Scale

#### **EXCAVATION AND BACKFILL**

\*EXCAVATION SHALL BE UNDERTAKEN IN SUCH A MANNER SO AS TO PREVENT DAMAGE TO EXISTING STRUCTURES, ADJACENT PROPERTY AND UTILITIES

\*THE TOPSOIL AND VEGETABLE MATTER IN UNEXCAVATED AREAS UNDER A BUILDING SHALL BE REMOVED. THE BOTTOM OF EXCAVATIONS FOR FOUNDATIONS

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#### DAMP PROOFING AND DRAINAGE

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\*MASONRY FOUNDATION WALLS SHALL BE PARGED WITH 6mm OF MORTAR COVERED OVER THE FOOTING PRIOR TO DAMP PROOFING

\*100mm DIA. FOUNDATION DRAINS SHALL BE LAID ON LEVEL, UNDISTURBED GROUND ADJACENT TO THE FOOTINGS AT OR BELOW THE TOP OF THE

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DITCH, DRY WELL OR SUMP

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\*THE BUILDING SITE SHALL BE GRADED SO THAT SURFACE, SUMP, AND ROOF DRAINAGE WILL NOT ACCUMULATE AT OR NEAR THE BUILDING AND WILL NOT ADVERSELY AFFECT ADJACENT PROPERTIES

### **FOOTINGS**

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\*MINIMUM 1200mm BELOW FINISHED GRADE

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100KPA FOR ICF

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SUPPORTED EXT. WALL INT. WALL AREA 0.40m2 250mm 200mm 0.75m2 350mm 350mm 500mm 1.00m2 450mm

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\*INCREASE INTERIOR FOOTING WIDTH BY 100mm FOR EACH STOREY OF MASONRY ABOVE FOOTING AND BY 100mm FOR EACH 2700mm OF WALL HEIGHT ABOVE 5500mm

\*THE PROJECTION OF AN UNREINFORCED FOOTING BEYOND THE WALL SUPPORTED SHALL NOT BE GREATER THAN ITS **THICKNESS** 

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\*TO BE POURED CONCRETE, UNIT MASONRY, ICF OR PRESERVED WOOD (SEE DRAWINGS FOR TYPE AND THICKNESS) \*DAMP PROOFING SHALL BE A HEAVY COAT OF BITUMINOUS MATERIAL

\*FOUNDATION WALL TO EXTEND MINIMUM 150mm ABOVE FINISHED GRADE

\*A DRAINAGE LAYER IS REQUIRED ON THE OUTSIDE OF A FOUNDATION WALL WHERE THE INTERIOR INSULATION EXTENDS MORE THAN 900mm BELOW

EXTERIOR GRADE. A DRAINAGE LAYER SHALL CONSIST OF

-MIN. 19mm MINERAL FIBRE INSULATION WITH MIN. DENSITY OF 57KG/m3

-MIN. 100mm OF FREE DRAINAGE GRANULAR MATERIAL, OR

-AN APPROVED SYSTEM WHICH PROVIDES EQUIVALENT PERFORMANCE

\*FOUNDATION WALLS SHALL BE BRACED OR HAVE THE FLOOR JOISTS INSTALLED BEFORE BACKFILLING

## **CONCRETE FLOOR SLABS**

\*GARAGE, CARPORT AND EXTERIOR SLABS AND EXTERIOR STEPS SHALL BE 32MPA CONCRETE WITH 5-8% AIR ENTRAINMENT \*BASEMENT SLAB 25MPA CONCRETE, MINIMUM 75mm THICK, PLACED ON A MINIMUM 100mm OF COARSE, CLEAN, GRANULAR MATERIAL

\*ALL FILL OTHER THAN COARSE, CLEAN MATERIAL PLACED BENEATH CONCRETE SLABS SHALL BE COMPACTED TO PROVIDE UNIFORM SUPPORT

### **MASONRY WALLS**

\*WHERE CONSTRUCTED OF 90mm BRICK, WALL SHALL BE BONDED WITH A HEADER COURSE EVERY 600mm O/C VERTICALLY AND HORIZONTALLY AND 900mm

O/C FOR BLOCK OR TILE

\*PROVIDE 50mm SOLID MASONRY, CONCRETE FILLED TOP COURSE OR CONTINUOUS 38X89 WOOD PLATE UNDER ALL ROOF AND FLOOR FRAMING MEMBERS

\*PROVIDE 190mm SOLID MASONRY UNDER BEAMS AND COLUMNS

\*MASONRY WALL TO BE TIED TO EACH TIER OF JOISTS WITH 40mm X 4.76mm CORROSION RESISTANT STEEL STRAPS, KEYED MINIMUM 100mm INTO

MASONRY. WHEN JOISTS ARE PARALLEL TO WALL, TIES ARE TO EXTEND ACROSS AT LEAST 3 JOISTS @ 2000mm O.C.

\*INSIDE OF WALL TO BE PARGED AND COVERED WITH NO. 15 BREATHER-TYPE ASPHALT PAPER \*FOR REDUCED FOUNDATION WALLS TO ALLOW A BRICK FACING WHILE MAINTAINING LATERAL SUPPORT, TIE MINIMUM 90mm BRICK TO MINIMUM 90mm

BACKUP BLOCK WITH CORROSION RESISTANT TIES AT LEAST 17.8m2 IN CROSS SECTIONAL AREA, SPACED 200mm VERTICALLY AND 900mm HORIZONTALLY,

WITH JOINTS COMPLETELY FILLED WITH MORTAR

\*MASONRY OVER OPENINGS SHALL BE SUPPORTED ON CORROSION RESISTANT OR PRIME PAINTED STEEL LINTELS WITH A

MINIMUM OF 150mm END BEARING.

#### **MASONRY VENEER**

\*MINIMUM 70mm THICK IF JOINTS ARE NOT RAKED AND 90mm THICK IF JOINTS ARE RAKED

\*MINIMUM 25mm AIR SPACE TO SHEATHING

\*PROVIDE WEEP HOLES @ 800mm O.C. AT THE BOTTOM OF THE CAVITY AND OVER THE DOORS AND WINDOWS \*DIRECT DRAINAGE THROUGH WEEP HOLES WITH 0.5mm POLY FLASHING EXTENDING MINIMUM 150mm UP BEHIND THE SHEATHING PAPER

\*VENEER TIES MINIMUM 0.76mm THICK X 22mm WIDE CORROSION RESISTANT STRAPS SPACED @ 500mm

**VERTICALLY AND 600mmHORIZONTALLY** 

\*FASTEN TIES WITH CORROSION RESISTANT 3.18mm DIAMETER SCREWS OR SPIRAL NAILS WHICH PENETRATE AT LEAST 30mm INTO STUDS

#### **WOOD FRAME CONSTRUCTION**

\*ALL LUMBER SHALL BE SPRUCE-PINE-FIR NO. 1 & 2, AND SHALL BE IDENTIFIED BY A GRADE STAMP \*MAXIMUM MOISTURE CONTENT 19% AT TIME OF INSTALLATION

\*WOOD FRAMING MEMBERS WHICH ARE SUPPORTED ON CONCRETE IN DIRECT CONTACT WITH SOIL SHALL BE SEPARATED FROM THE CONCRETE WITH

0.05mm POLYETHYLENE OR TYPE 'S' ROLL ROOFING WALLS

\*EXTERIOR WALLS SHALL CONSIST OF:

-CLADDING

-AIR BARRIER SYSTEM LAPPED 100mm AT JOINTS

-LUMBER, PLYWOOD, OSB OR GYPSUM SHEATHING

-38X140 STUDS @ 400mm O.C.

RSI PER TABLE PROVIDED

-38X140 BOTTOM PLATE -38X140 DOUBLE TOP PLATE

\*INTERIOR LOAD BEARING WALLS SHALL CONSIST OF: -38X89 STUDS @ 400mm O.C.

-38X89 BOTTOM PLATE AND DOUBLE 38X89 TOP PLATE

-38X89 MID-GIRTHS IF NOT SHEATHED

-12.7mm GYPSUM BOARD SHEATHING

## **FLOORS**

\*SEE STRUCTURAL ENGINEERING DRAWINGS FOR FLOOR JOIST SIZE AND SPACING REQUIREMENTS

\*JOISTS TO HAVE MINIMUM 38mm OF END BEARING

\*JOISTS SHALL BEAR ON A SILL PLATE FIXED TO FOUNDATION WITH 12.7mm ANCHOR BOLTS @ 2400mm O.C

\*HEADER JOISTS BETWEEN 1200mm AND 3200mm IN LENGTH SHALL BE SIZED BY CALCULATIONS \*TRIMMER JOISTS SHALL BE DOUBLED WHEN SUPPORTED HEADER IS BETWEEN 800mm AND 2000mm, TRIMMER JOISTS

SHALL BE SIZED BY CALCULATIONS WHEN SUPPORTED HEADER EXCEEDS 2000mm.

\*38X38 CROSS BRIDGING REQUIRED NOT MORE THAN 2100MM FROM EACH SUPPORT AND FROM OTHER ROWS OF BRIDGING

\*JOISTS SHALL BE SUPPORTED ON JOISTS HANGERS AT ALL FLUSH BEAMS, TRIMMERS, AND HEADERS \*NON-LOAD BEARING PARTITIONS SHALL BE SUPPORTED ON A JOISTS OR ON BLOCKING BETWEEN JOISTS \*SEE STRUCTURAL ENGINEERING DRAWINGS FOR SUBFLOORING REQUIREMENTS

## **ROOF AND CEILINGS**

\*SEE STRUCTURAL ENGINEERING DRAWINGS FOR ROOF CONSTRUCTION SIZING AND SPACING REQUIREMENTS \*HIP AND VALLEY RAFTER SHALL BE 38mm DEEPER THAN COMMON RAFTERS

\*38X89 COLLAR TIES @ RAFTER SPACING WITH 19X89 CONTINUOUS BRACE AT MID SPAN IF COLLAR TIE **EXCEEDS 2400mm IN LENGTH** 

\*SEE STRUCTURAL DRAWINGS FOR ROOF SHEATHING REQUIREMENTS

## **NOTCHING & DRILLING OF TRUSSES, JOISTS, RAFTERS**

\*HOLES IN FLOOR, ROOF AND CEILING MEMBERS TO BE NOT LARGER THAN 1/4 THE ACTUAL DEPTH OF MEMBER AND NOT

LESS THAN 50mm FROM EDGES

\*NOTCHES IF FLOOR, ROOF AND CEILING MEMBERS TO BE LOCATED ON TOP OF THE MEMBER WITHIN 1/2 THE ACTUAL DEPTH FROM THE EDGE OF BEARING


AND NOT GREATER THAN 1/3 THE JOIST DEPTH

\*WALL STUDS MAY BE NOTCHED OR DRILLED PROVIDED THAT NO LESS THAN 2/3 THE DEPTH OF THE STUD REMAINS, IF LOAD BEARING AND 40mm IF NON -LOAD BEARING

\*ROOF TRUSS MEMBERS SHALL NOT BE NOTCHED, DRILLED OR WEAKENED UNLESS ACCOMMODATED IN THE DESIGN

\*Wall studs may be notched or drilled provided that no less than 2/3 the depth of the stud remains, if load bearing and 40mm if non - load bearing

\*Roof truss members shall not be notched, drilled or weakened unless accommodated in the design

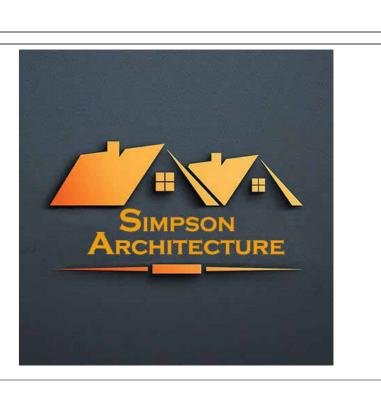

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REGISTRATION INFORMATION

Required unless the design is exempt under 2.17.5.1. of the Building Code

No.	Description	Date

### The Jackson's

27 Brock St. Penetanguishene, ON L9M

## **General Notes**

25-009 **Project Number** 25-07-03 **Issued For Permit Date** Justin Simpson Drawn By 123605 BCIN#

A01.2


Scale

SURVEY INFORMATION AND PROPERTY LINES

HAVE BEEN GENERATED FROM:

HTTPS://OPENGIS.SIMCOE.CA/?MAP\_ID=ZONING-BWG. ALL PROPERTY LINE AND SURVEY
INFORMATION IS TO BE CONFIRMED ON SITE BY
CONTRACTOR AND THIS DRAWING IS TO BE
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INFORMATION HAS BEEN PROVIDED FOR THE
ADDRESS: 27 BROCK ST. PENETANGUISHENE, ON

L9M 1R9

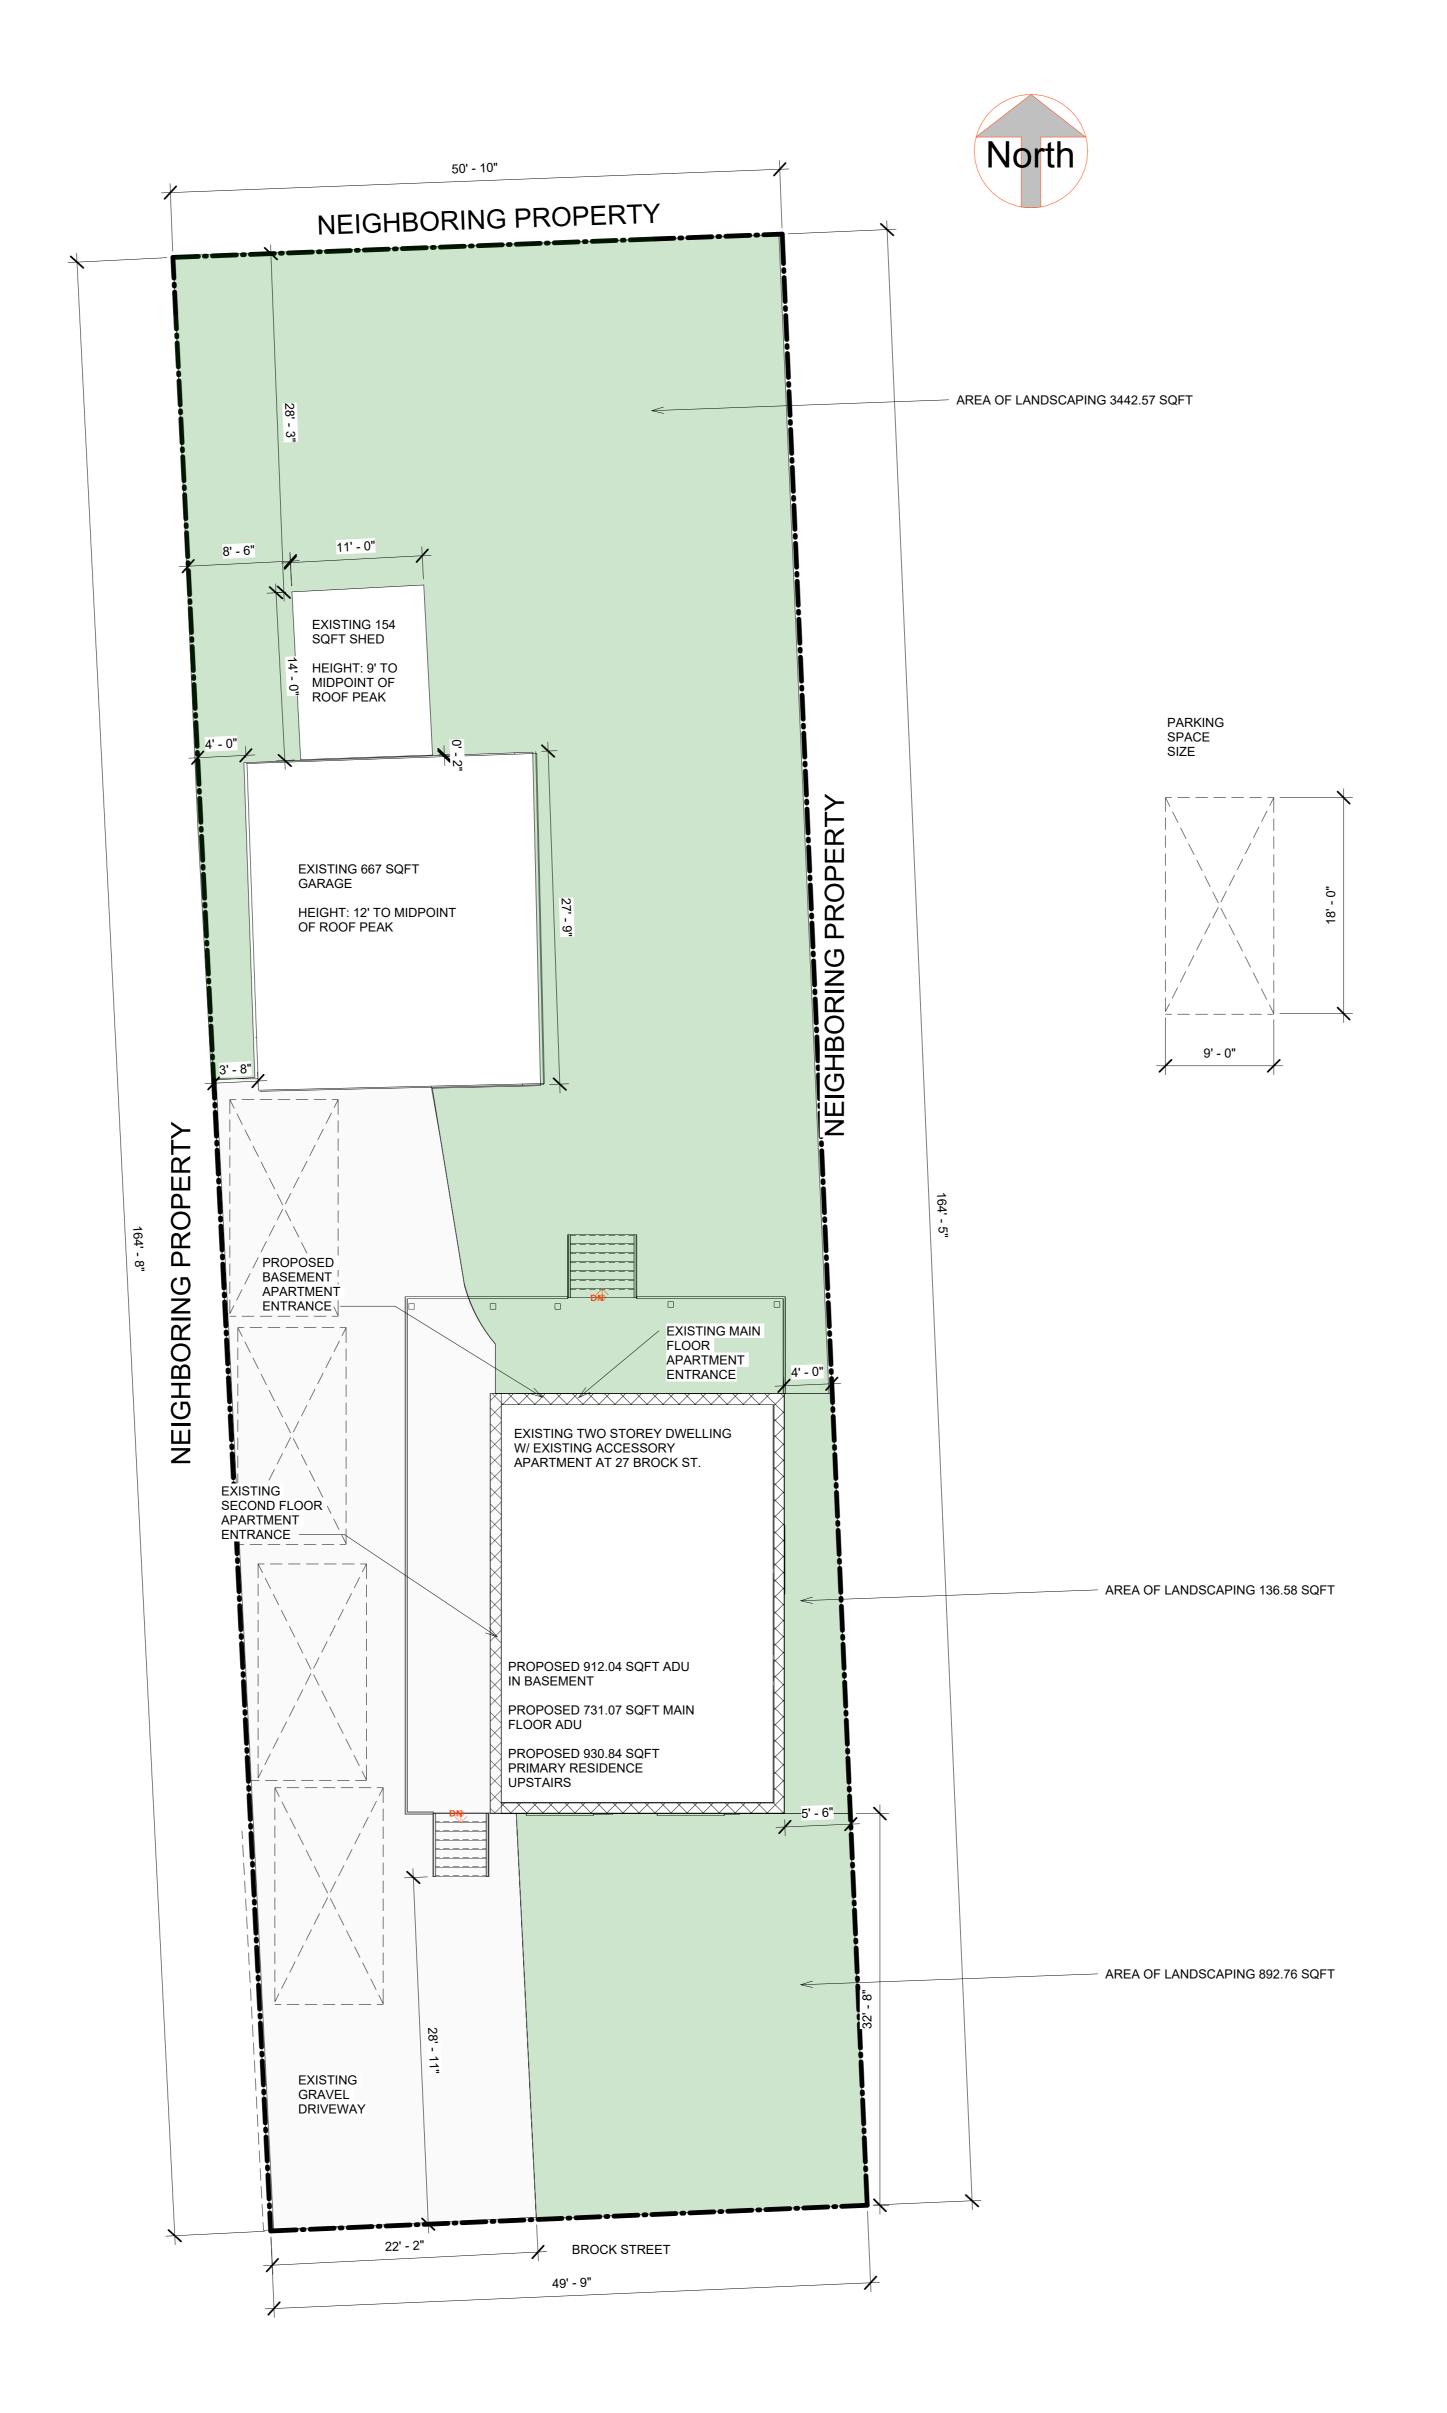



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QUALIFICATION INFORMATION

REGISTRATION INFORMATION

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Justin Simpson O/A Simpson Architecture

FIRM NAME

No.	Description	Date

## The Jackson's

27 Brock St.
Penetanguishene, ON L9M
1R9

## Site Plan

 Project Number
 25-009


 Issued For Permit Date
 25-07-03

 Drawn By
 Justin Simpson

 BCIN #
 123605

A02

Scale 1/8" = 1'-0'

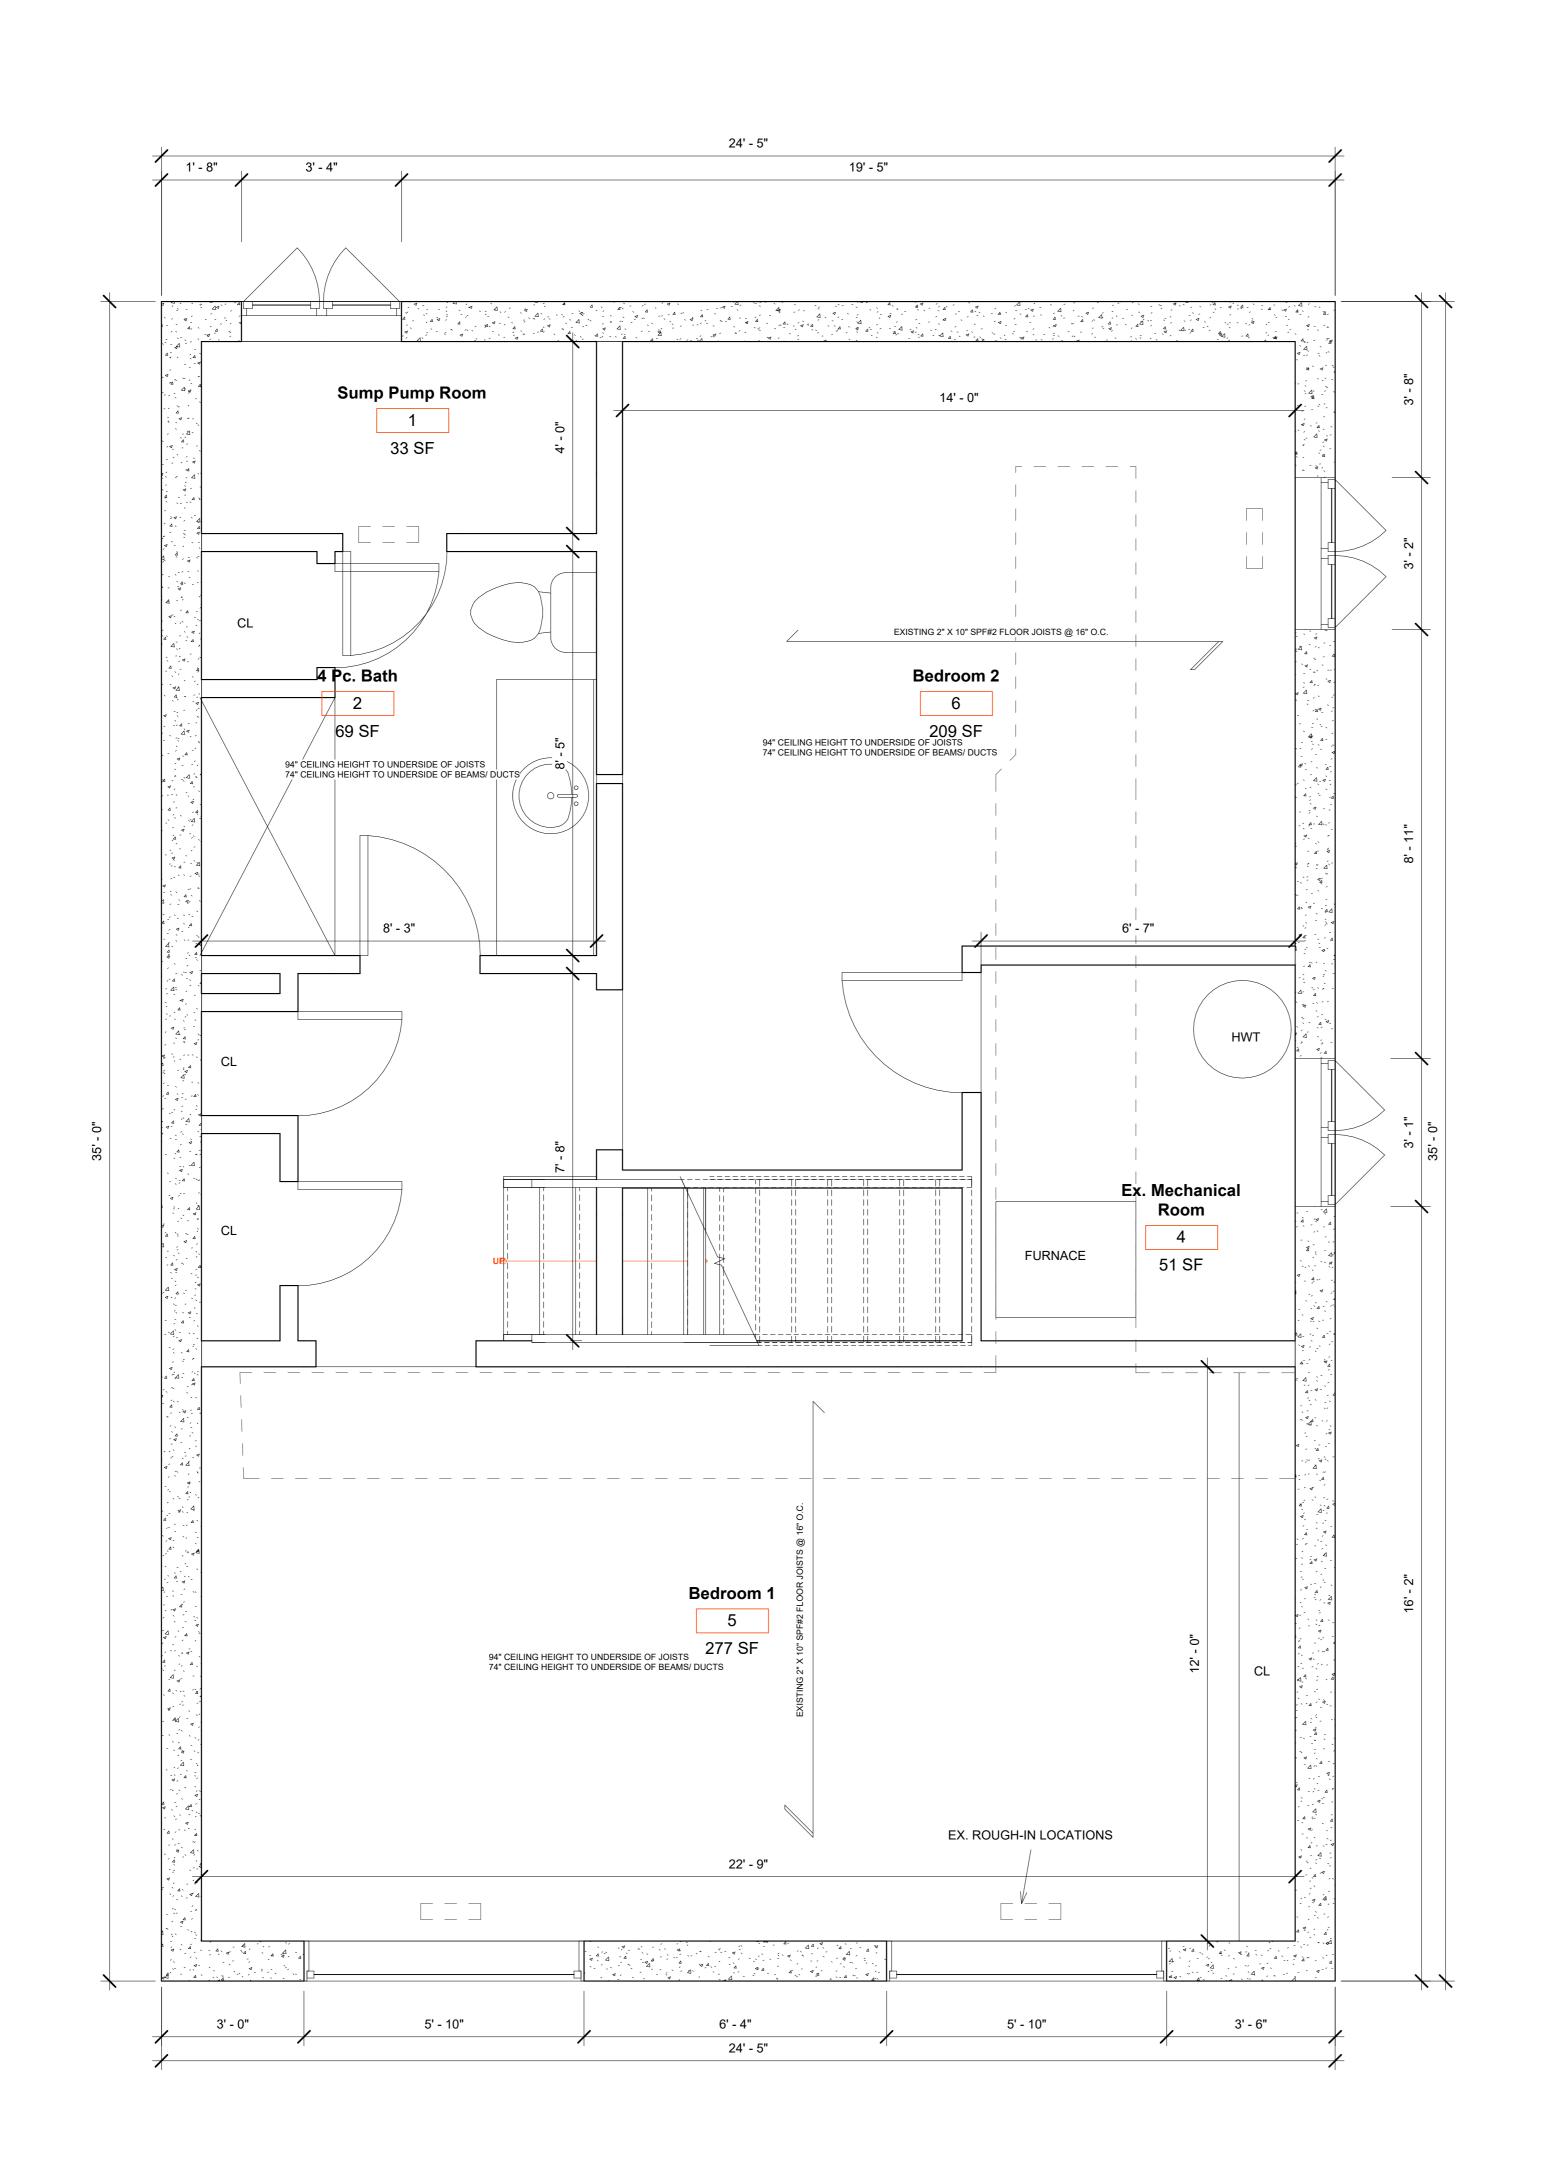



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Justin Simpson

Justin Simpson

Digitally signed by Justin Simpson
Date: 2024.11.29 1431:39 0:500°

REGISTRATION INFORMATION

SIGNATURE

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Justin Simpson O/A Simpson Architecture

No.	Description	Date

## The Jackson's

27 Brock St. Penetanguishene, ON L9M 1R9

## Existing Basement Plan

 Project Number
 25-009

 Issued For Permit Date
 25-07-03


 Drawn By
 Justin Simpson


 BCIN #
 123605

A03

Scale

1/2" = 1'-0'

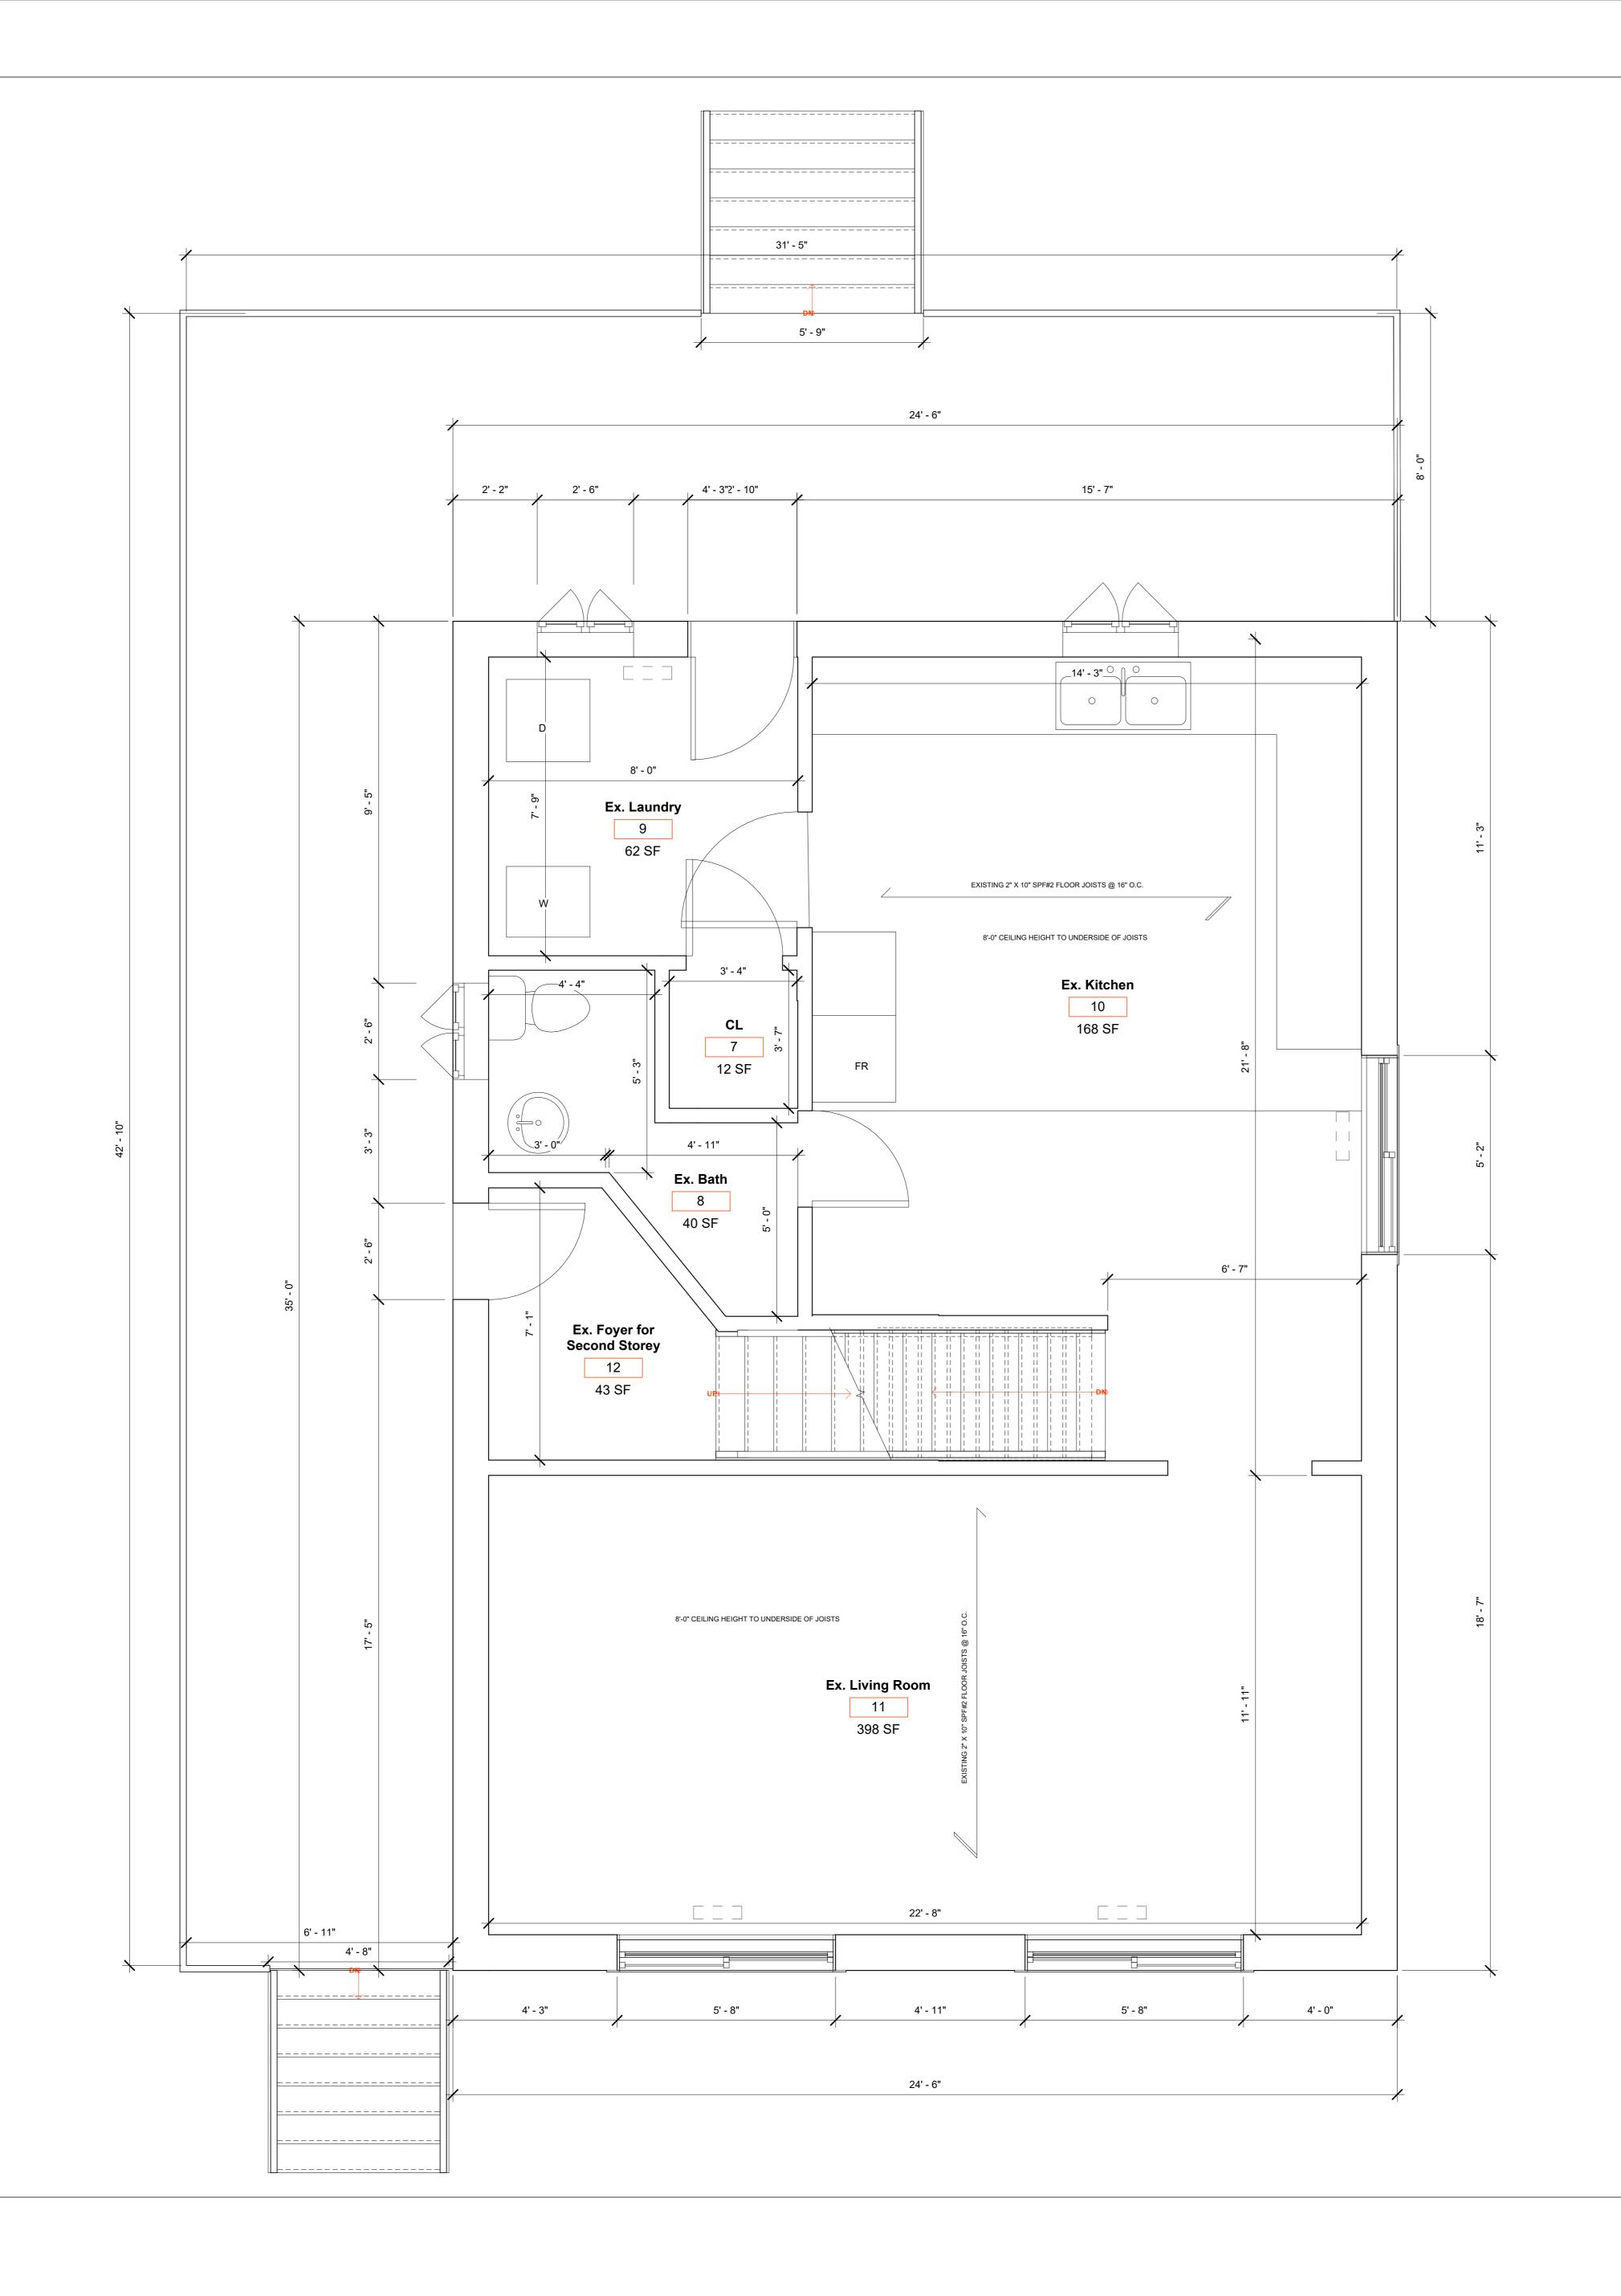

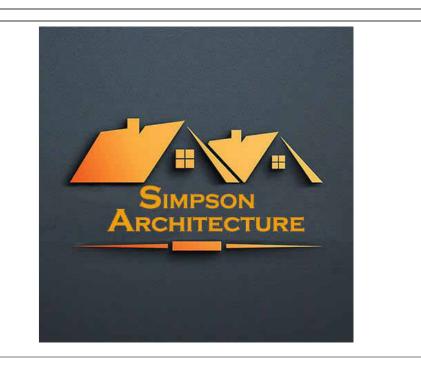

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Justin Simpson Justin Simpson Digitally signed by Justin Simpson Date 2024.11.29.14.31:39-05'90' 12

NAME SIGNATURE BO

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No.	Description	Date

## The Jackson's

27 Brock St. Penetanguishene, ON L9M 1R9

## Existing Main Floor Plan

 Project Number
 25-009


 Issued For Permit Date
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 Drawn By
 Justin Simpson


 BCIN #
 123605

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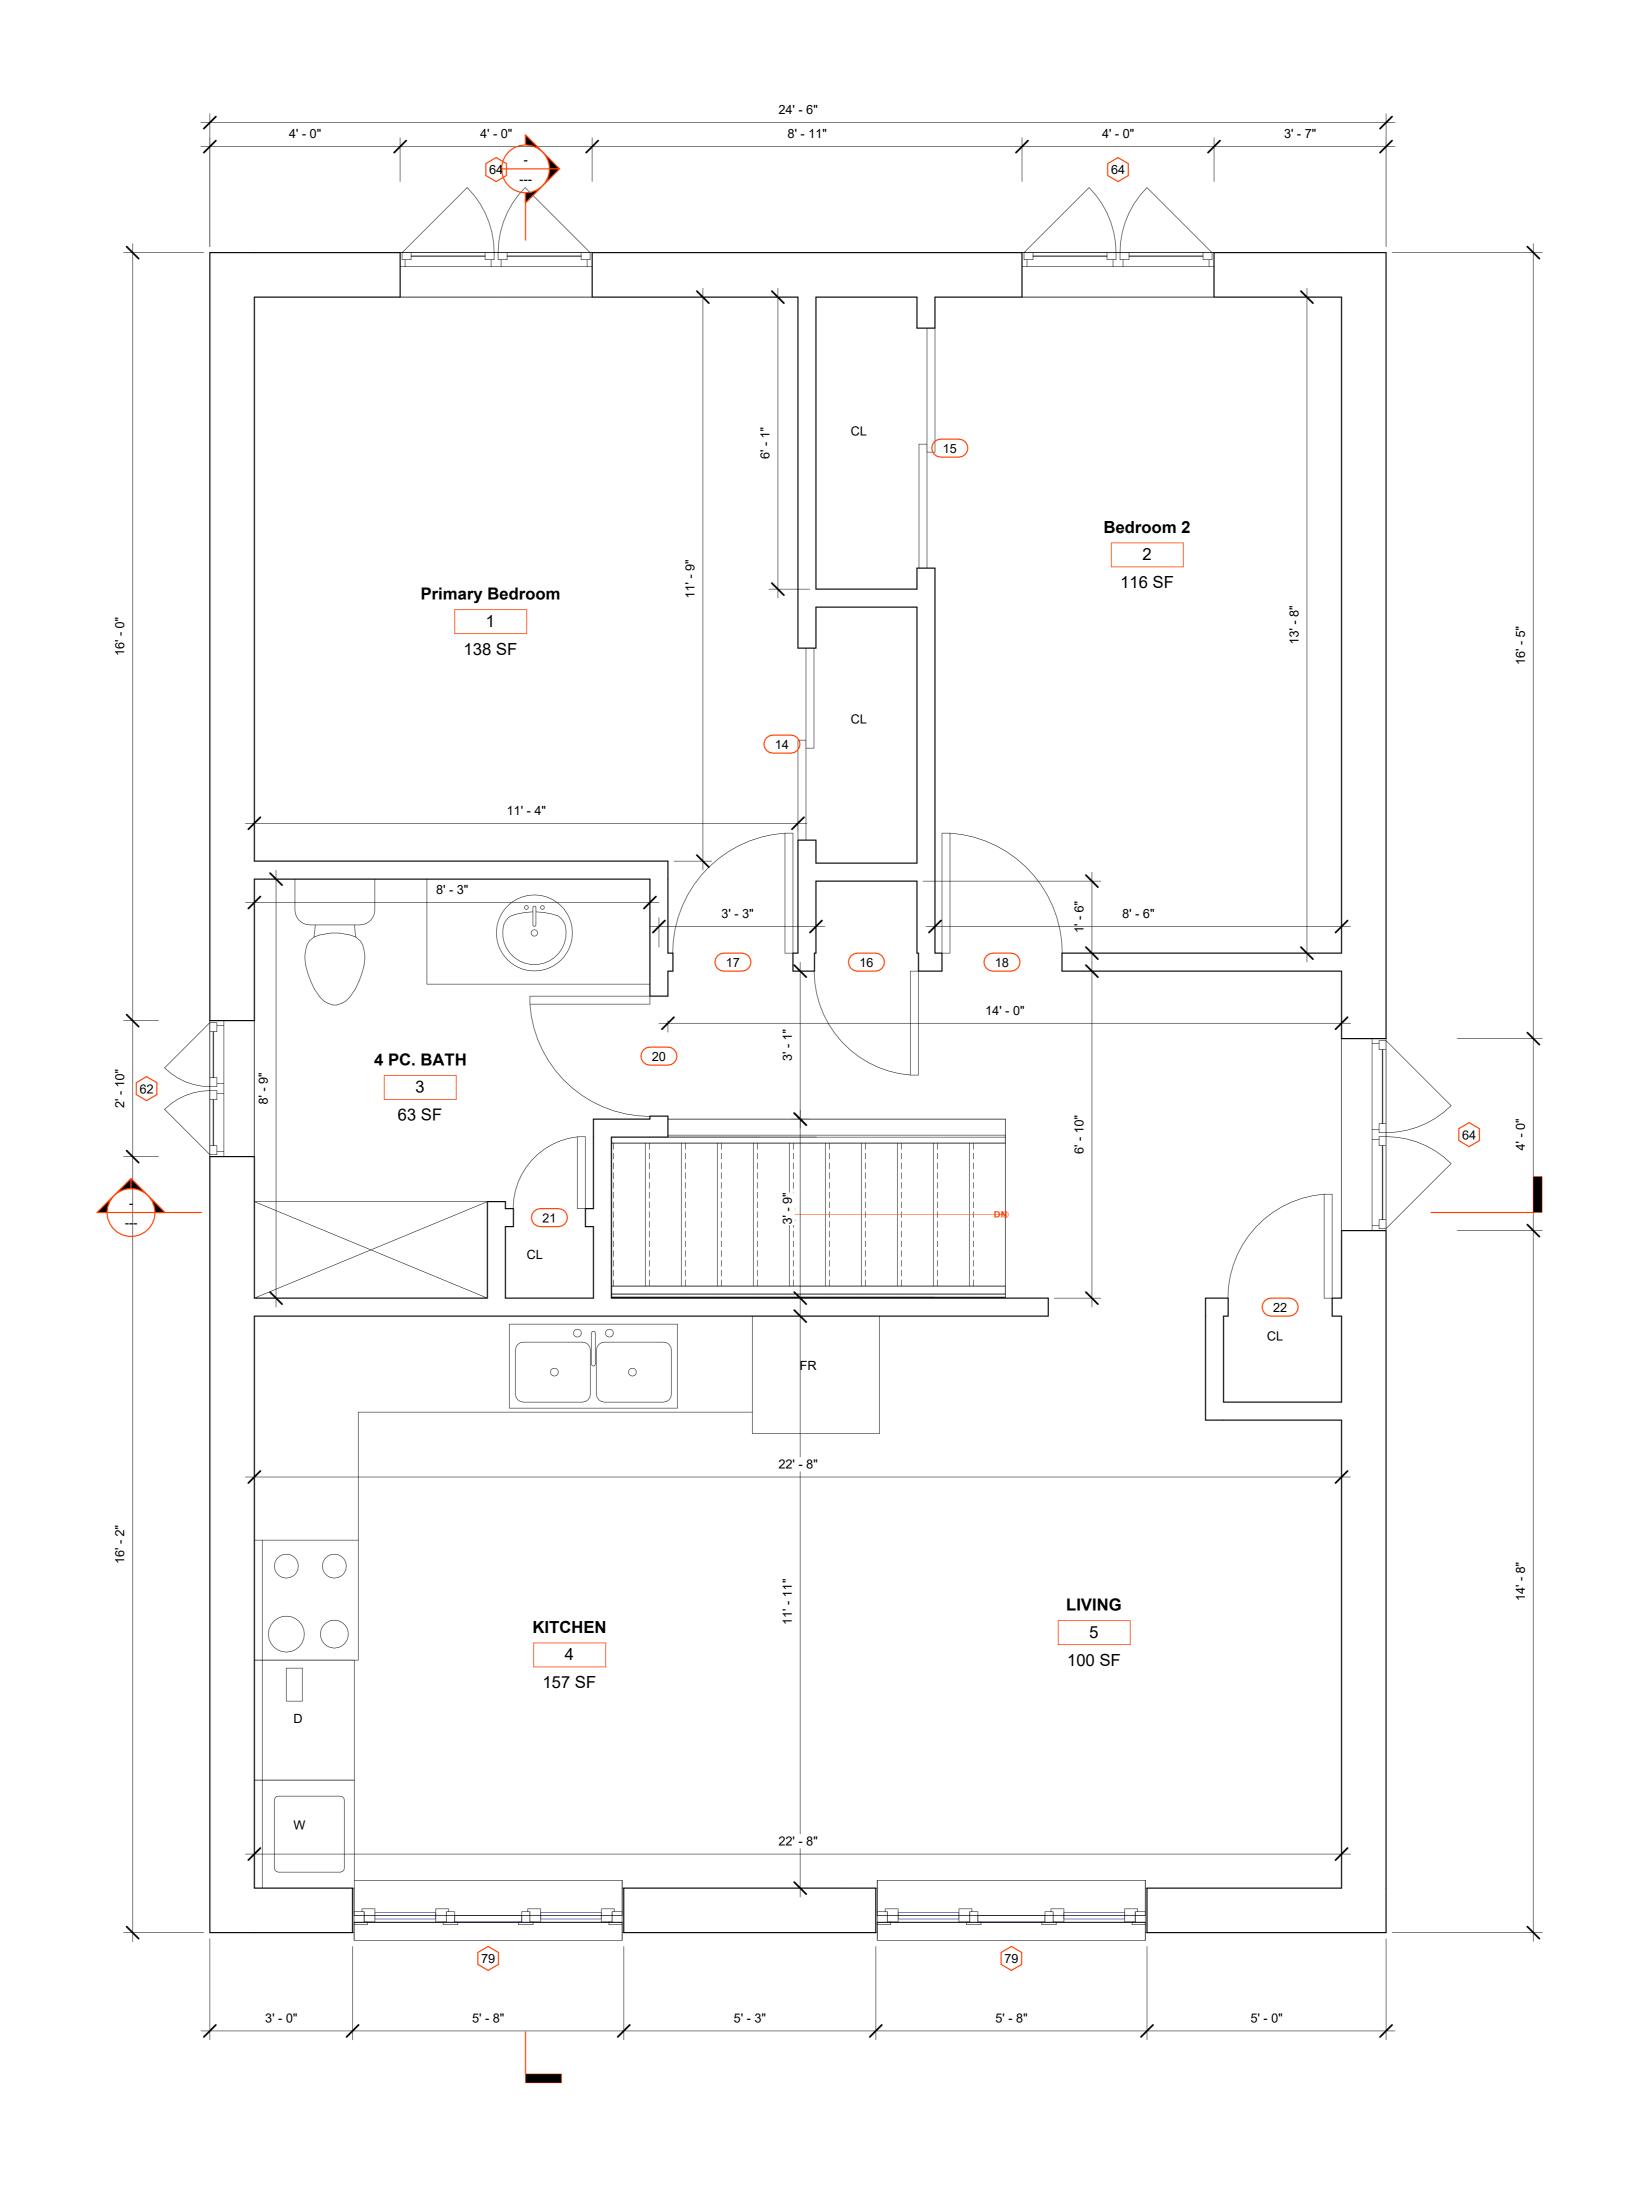
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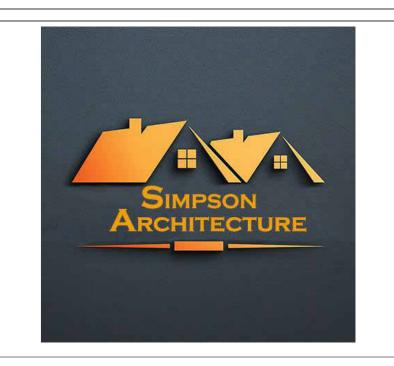


Door Schedule						
Door Number	Door Type	Width	Height	Sill Height	Phase Created	Header Size
5	37	2' - 6"	7' - 0"	0' - 0"	Existing	
7	37	2' - 6"	7' - 0"	0' - 0"	Existing	
8	62	2' - 8"	6' - 8"	0' - 0"	Existing	
9	37	2' - 6"	7' - 0"	0' - 0"	New Construction	2-2" x 6" SPF#2 L.B. ONLY
10	37	2' - 6"	7' - 0"	0' - 0"	New Construction	2-2" x 6" SPF#2 L.B. ONLY
11	37	2' - 6"	7' - 0"	0' - 0"	New Construction	2-2" x 6" SPF#2 L.B. ONLY
14	54	4' - 0"	6' - 8"	0' - 0"	New Construction	2-2" X 12" SPF#2 L.B. ONLY
15	52	5' - 0"	7' - 0"	0' - 0"	New Construction	2-2" X 12" SPF#2 L.B. ONLY
16	57	2' - 2"	6' - 8"	0' - 0"	New Construction	2-2" x 6" SPF#2 L.B. ONLY
17	38	2' - 6"	6' - 8"	0' - 0"	New Construction	2-2" x 6" SPF#2 L.B. ONLY
18	38	2' - 6"	6' - 8"	0' - 0"	New Construction	2-2" x 6" SPF#2 L.B. ONLY
20	38	2' - 6"	6' - 8"	0' - 0"	New Construction	2-2" x 6" SPF#2 L.B. ONLY
21	58	1' - 6"	6' - 8"	0' - 0"	New Construction	2-2" x 6" SPF#2 L.B. ONLY
22	57	2' - 2"	6' - 8"	0' - 0"	New Construction	2-2" x 6" SPF#2 L.B. ONLY
23	37	2' - 6"	7' - 0"	0' - 0"	Existing	
24	62	2' - 8"	6' - 8"	0' - 0"	New Construction	2-2" x 6" SPF#2 L.B. ONLY
25	37	2' - 6"	7' - 0"	0' - 0"	New Construction	2-2" x 6" SPF#2 L.B. ONLY
26	37	2' - 6"	7' - 0"	0' - 0"	New Construction	2-2" x 6" SPF#2 L.B. ONLY
28	37	2' - 6"	7' - 0"	0' - 0"	New Construction	2-2" x 6" SPF#2 L.B. ONLY
29	37	2' - 6"	7' - 0"	0' - 0"	New Construction	2-2" x 6" SPF#2 L.B. ONLY
30	57	2' - 2"	6' - 8"	0' - 0"	New Construction	2-2" x 6" SPF#2 L.B. ONLY
31	38	2' - 6"	6' - 8"	0' - 0"	New Construction	2-2" x 6" SPF#2 L.B. ONLY
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33	57	2' - 2"	6' - 8"	0' - 0"	Existing	
34	38	2' - 6"	6' - 8"	0' - 0"	Existing	
36	36	2' - 8"	7' - 0"	0' - 0"	New Construction	2-2" x 6" SPF#2 L.B. ONLY
37	57	2' - 2"	6' - 8"	0' - 0"	Existing	
38	57	2' - 2"	6' - 8"	0' - 0"	Existing	
40	34	3' - 0"	7' - 0"	0' - 0"	Existing	
41	34	3' - 0"	7' - 0"	0' - 0"	New Construction	2-2" x 6" SPF#2 L.B. ONLY
43	57	2' - 2"	6' - 8"	0' - 0"	New Construction	2-2" x 6" SPF#2 L.B. ONLY
45	37	2' - 6"	7' - 0"	0' - 0"	New Construction	2-2" x 6" SPF#2 L.B. ONLY
46	55	5' - 0"	6' - 8"	0' - 0"	New Construction	2-2" X 12" SPF#2 L.B. ONLY
47	37	2' - 6"	7' - 0"	0' - 0"	Existing	
49	37	2' - 6"	7' - 0"	0' - 0"	New Construction	2-2" x 6" SPF#2 L.B. ONLY

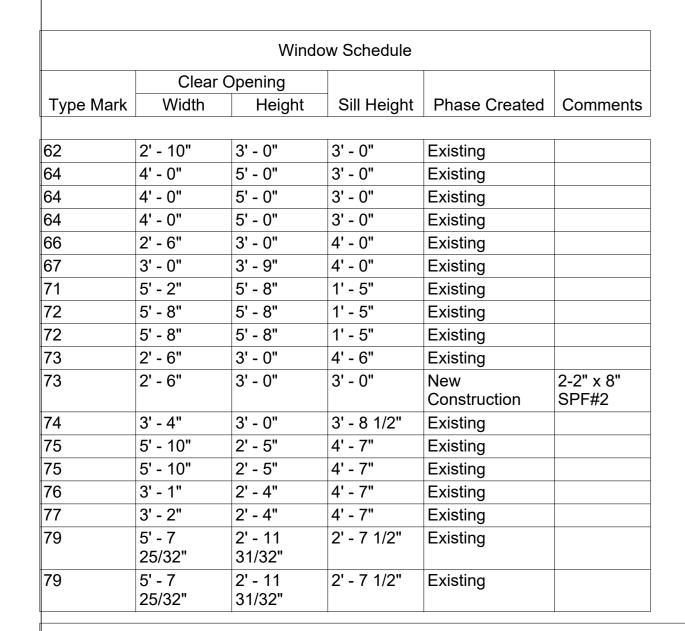

AREA LEGEND					
IMAGE	AREA				
	BASEMENT AREA LOCATION	912.04 SQFT			
	UPSTAIRS AREA LOCATION	930.84 SQFT			
	MAIN FLOOR AREA LOCATION	828.75 SQFT			

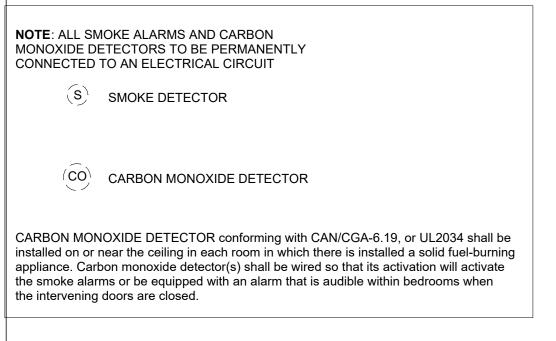



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QUALIFICATION INFORMATION

Required unless the design is exempt under 2.17.5.1. of the Building Code

Justin Simpson

Justin Simpson

SIGNATURE

BCIN

REGISTRATION INFORMATION

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Justin Simpson O/A Simpson Architecture

No.	Description	Date

## The Jackson's

27 Brock St. Penetanguishene, ON L9M 1R9

## Existing Second Floor Plan

Project Number 25-009
Issued For Permit Date 25-07-03
Drawn By Justin Simpson
BCIN # 123605

A05

Scale As indicated





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Justin Simpson Digitally signed by Justin Simpson Date: 2024.11.29 14:31:39 -05'00'

NAME SIGNATURE

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Justin Simpson O/A Simpson Architecture

No. Description Date

## The Jackson's

27 Brock St. Penetanguishene, ON L9M 1R9

## Elevation

 Project Number
 25-009

 Issued For Permit Date
 25-07-03

 Drawn By
 Justin Simpson

 BCIN #
 123605

AOG

Scale 3/4" = 1'-0"

Door Number [	<b>.</b> .			Door Schedule					
Number [									
	Door Type	Width	Height	Sill Height	Phase Created	Header Size			
5 3	57	2' - 6"	7' - 0"	0' - 0"	Existing				
7 3	57	2' - 6"	7' - 0"	0' - 0"	Existing				
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9 3	37	2' - 6"	7' - 0"	0' - 0"	New Construction	2-2" x 6" SPF#2 L.B. ONLY			
10 3	37	2' - 6"	7' - 0"	0' - 0"	New Construction	2-2" x 6" SPF#2 L.B. ONLY			
11 3	37	2' - 6"	7' - 0"	0' - 0"	New Construction	2-2" x 6" SPF#2 L.B. ONLY			
14 54	54	4' - 0"	6' - 8"	0' - 0"	New Construction	2-2" X 12" SPF#2 L.B. ONLY			
15 52	52	5' - 0"	7' - 0"	0' - 0"	New Construction	2-2" X 12" SPF#2 L.B. ONLY			
16 5	57	2' - 2"	6' - 8"	0' - 0"	New Construction	2-2" x 6" SPF#2 L.B. ONLY			
17 38	8	2' - 6"	6' - 8"	0' - 0"	New Construction	2-2" x 6" SPF#2 L.B. ONLY			
18 38	8	2' - 6"	6' - 8"	0' - 0"	New Construction	2-2" x 6" SPF#2 L.B. ONLY			
20 38	8	2' - 6"	6' - 8"	0' - 0"	New Construction	2-2" x 6" SPF#2 L.B. ONLY			
21 58	i8	1' - 6"	6' - 8"	0' - 0"	New Construction	2-2" x 6" SPF#2 L.B. ONLY			
22 5	57	2' - 2"	6' - 8"	0' - 0"	New Construction	2-2" x 6" SPF#2 L.B. ONLY			
23 3	37	2' - 6"	7' - 0"	0' - 0"	Existing				
24 62	52	2' - 8"	6' - 8"	0' - 0"	New Construction	2-2" x 6" SPF#2 L.B. ONLY			
25 3 <sup>-</sup>	37	2' - 6"	7' - 0"	0' - 0"	New Construction	2-2" x 6" SPF#2 L.B. ONLY			
26 3 <sup>-</sup>	37	2' - 6"	7' - 0"	0' - 0"	New Construction	2-2" x 6" SPF#2 L.B. ONLY			
28 3	37	2' - 6"	7' - 0"	0' - 0"	New Construction	2-2" x 6" SPF#2 L.B. ONLY			
29 3 <sup>-</sup>	37	2' - 6"	7' - 0"	0' - 0"	New Construction	2-2" x 6" SPF#2 L.B. ONLY			
30 5	57	2' - 2"	6' - 8"	0' - 0"	New Construction	2-2" x 6" SPF#2 L.B. ONLY			
31 38	8	2' - 6"	6' - 8"	0' - 0"	New Construction	2-2" x 6" SPF#2 L.B. ONLY			
32 5 <sup>-</sup>	57	2' - 2"	6' - 8"	0' - 0"	Existing				
33 5	57	2' - 2"	6' - 8"	0' - 0"	Existing				
34 38	8	2' - 6"	6' - 8"	0' - 0"	Existing				
36 30	6	2' - 8"	7' - 0"	0' - 0"	New Construction	2-2" x 6" SPF#2 L.B. ONLY			
37 5	57	2' - 2"	6' - 8"	0' - 0"	Existing				
38 5	57	2' - 2"	6' - 8"	0' - 0"	Existing				
40 34	34	3' - 0"	7' - 0"	0' - 0"	Existing				
41 34	34	3' - 0"	7' - 0"	0' - 0"	New Construction	2-2" x 6" SPF#2 L.B. ONLY			
43 5	57	2' - 2"	6' - 8"	0' - 0"	New Construction	2-2" x 6" SPF#2 L.B. ONLY			
45 3	37	2' - 6"	7' - 0"	0' - 0"	New Construction	2-2" x 6" SPF#2 L.B. ONLY			
46 59	55	5' - 0"	6' - 8"	0' - 0"	New Construction	2-2" X 12" SPF#2 L.B. ONLY			
47 3	37	2' - 6"	7' - 0"	0' - 0"	Existing				
49 3	37	2' - 6"	7' - 0"	0' - 0"	New Construction	2-2" x 6" SPF#2 L.B. ONLY			

Type Mark	Clear Opening				
	Width	Height	Sill Height	Phase Created	Comments
00	01 4011	01 011	01 011	- · · ·	
62	2' - 10"	3' - 0"	3' - 0"	Existing	
64	4' - 0"	5' - 0"	3' - 0"	Existing	
64	4' - 0"	5' - 0"	3' - 0"	Existing	
64	4' - 0"	5' - 0"	3' - 0"	Existing	
66	2' - 6"	3' - 0"	4' - 0"	Existing	
67	3' - 0"	3' - 9"	4' - 0"	Existing	
71	5' - 2"	5' - 8"	1' - 5"	Existing	
72	5' - 8"	5' - 8"	1' - 5"	Existing	
72	5' - 8"	5' - 8"	1' - 5"	Existing	
73	2' - 6"	3' - 0"	4' - 6"	Existing	
73	2' - 6"	3' - 0"	3' - 0"	New Construction	2-2" x 8" SPF#2
74	3' - 4"	3' - 0"	3' - 8 1/2"	Existing	
75	5' - 10"	2' - 5"	4' - 7"	Existing	
75	5' - 10"	2' - 5"	4' - 7"	Existing	
76	3' - 1"	2' - 4"	4' - 7"	Existing	
77	3' - 2"	2' - 4"	4' - 7"	Existing	
79	5' - 7 25/32"	2' - 11 31/32"	2' - 7 1/2"	Existing	
79	5' - 7 25/32"	2' - 11 31/32"	2' - 7 1/2"	Existing	

Window Schedule



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1. ALL DRAWINGS AND SPECIFICATIONS PROVIDED
HEREIN ARE CONSIDERED PROPRIETARY DOCUMENTS
CREATED BY SIMPSON ARCHITECTURE. THESE
MATERIALS ARE SAFEGUARDED UNDER INTELLECTUAL
PROPERTY RIGHTS AND MAY NOT BE REPLICATED,
DISSEMINATED, MODIFIED, OR SUBMITTED FOR
APPROVAL WITHOUT OBTAINING EXPLICIT WRITTEN
CONSENT FROM SIMPSON ARCHITECTURE.
UNAUTHORIZED USE, DISTRIBUTION, OR ALTERATION
OF THESE MATERIALS IS STRICTLY PROHIBITED.

2. ONLY VERIFIED FINAL DRAWINGS BEARING THE STAMP "FOR CONSTRUCTION PURPOSE" SHALL BE USED ON THE JOB SITE. DRAWINGS WITHOUT THE STAMP ARE CONSIDERED PRELIMINARY DRAWINGS ONLY.

3. ALL WORK INHERENT TO THIS PROJECT SHALL BE PERFORMED ACCORDING TO THE ONTARIO BUILDING CODE.

4. THE CONTRACTOR IS RESPONSIBLE FOR VERIFYING ALL LEVELS & DIMENSIONS, ANY DISCREPANCIES ARE TO BE REPORTED TO SIMPSON ARCHITECTURE BEFORE COMMENCING THE WORK.

5.NO MODIFICATION OF THE PLANS SHALL BE DONE WITHOUT THE WRITTEN APPROVAL OF SIMPSON ARCHITECTURE.

6. DIMENSIONS ON DRAWINGS SHALL GOVERN OVER SCALE.

7. THE CONTRACTOR SHALL BE RESPONSIBLE FOR ANY DEVIATIONS FROM THE ORIGINAL DRAWINGS, IF NOT AUTHORIZED WITH A WRITTEN CHANGE ORDER BY SIMPSON ARCHITECTURE

The undersigned has reviewed and takes responsibility for this design, and has the qualifications and meets the requirements set out in the Ontario Building Code to be a designer

QUALIFICATION INFORMATION

Required unless the design is exempt under 2.17.5.1. of

FIRM NAME

Required unless the design is exempt under 2.17.5.1. of the Building Code

Justin Simpson Justin Simpson Digitally signed by Justin Simpson 123605

NAME SIGNATURE BCIN

REGISTRATION INFORMATION
Required unless the design is exempt under 2.17.5.1. of the Building Code

Required unless the design is exempt under 2.17.5.1. of the Building Code

Justin Simpson O/A Simpson Architecture

No.	Description	Date

## The Jackson's

27 Brock St. Penetanguishene, ON L9M 1R9

## Schedules

Project Number 25-009

Issued For Permit Date 25-07-03

Drawn By Justin Simpson

BCIN # 123605

A07

Scale