

5'-41" 5'-41" EXISTING POLE BARN 20'-6<u>1</u>" F1 TYPICAL: 24"Ø X 48" THICK CONCRETE FOOTING

1 FOUNDATION PIER LAYOUT SCALE: 1/4" = 1'-0"

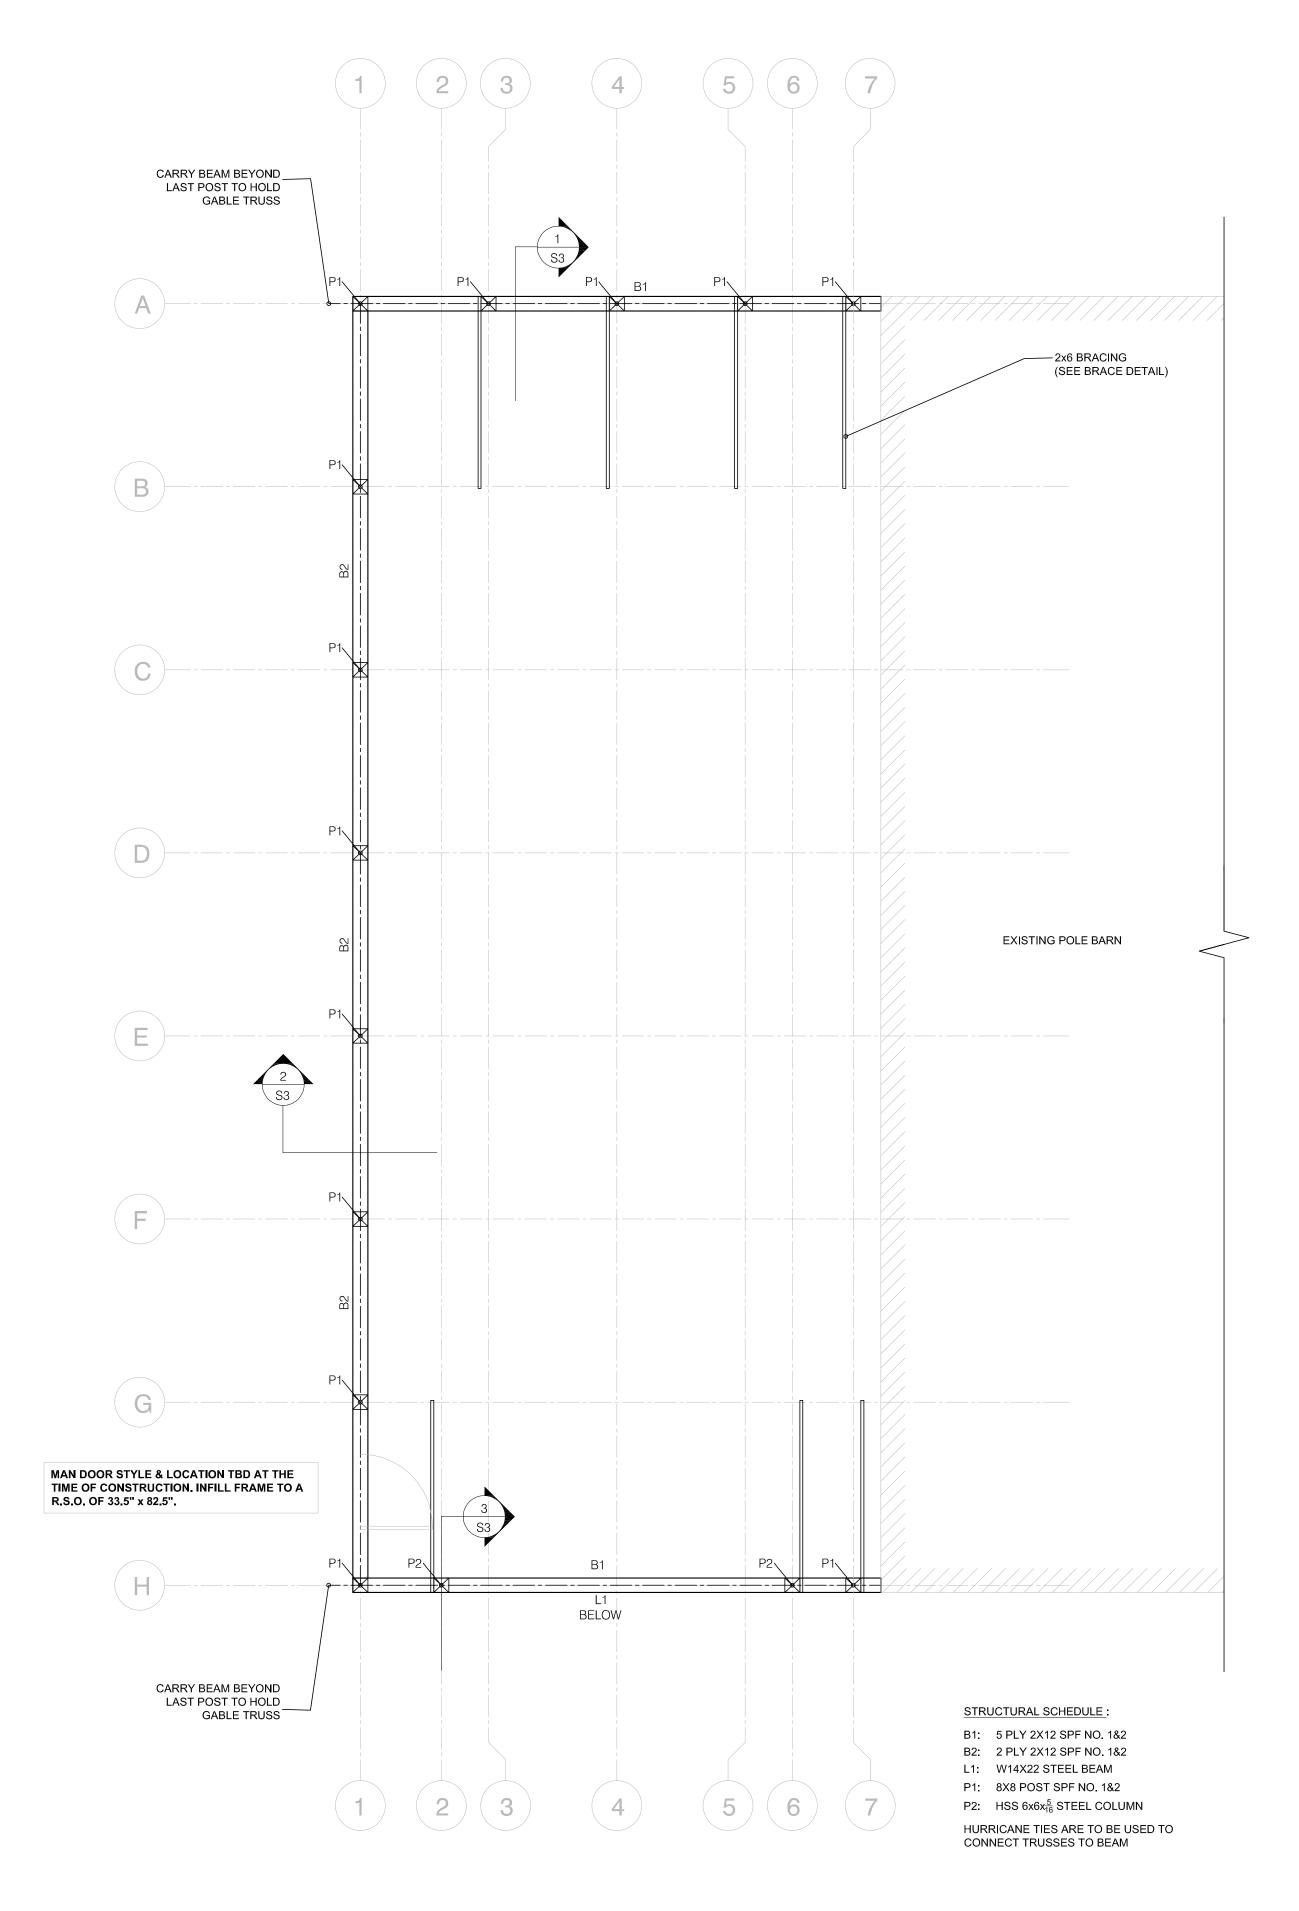

2 FLOOR PLAN
SCALE: 1/4" = 1'-0"

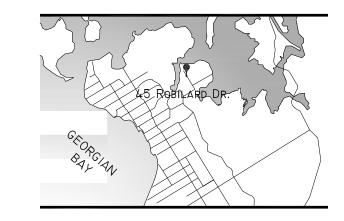

No	Revision	Date
1	Issued for Review & Approval	Oct. 05, 2021
2	Issued for Permit	Nov. 17, 2021
3	Revised for Permit	Nov. 23, 2023
4	Revised for Permit	Dec 19, 2023





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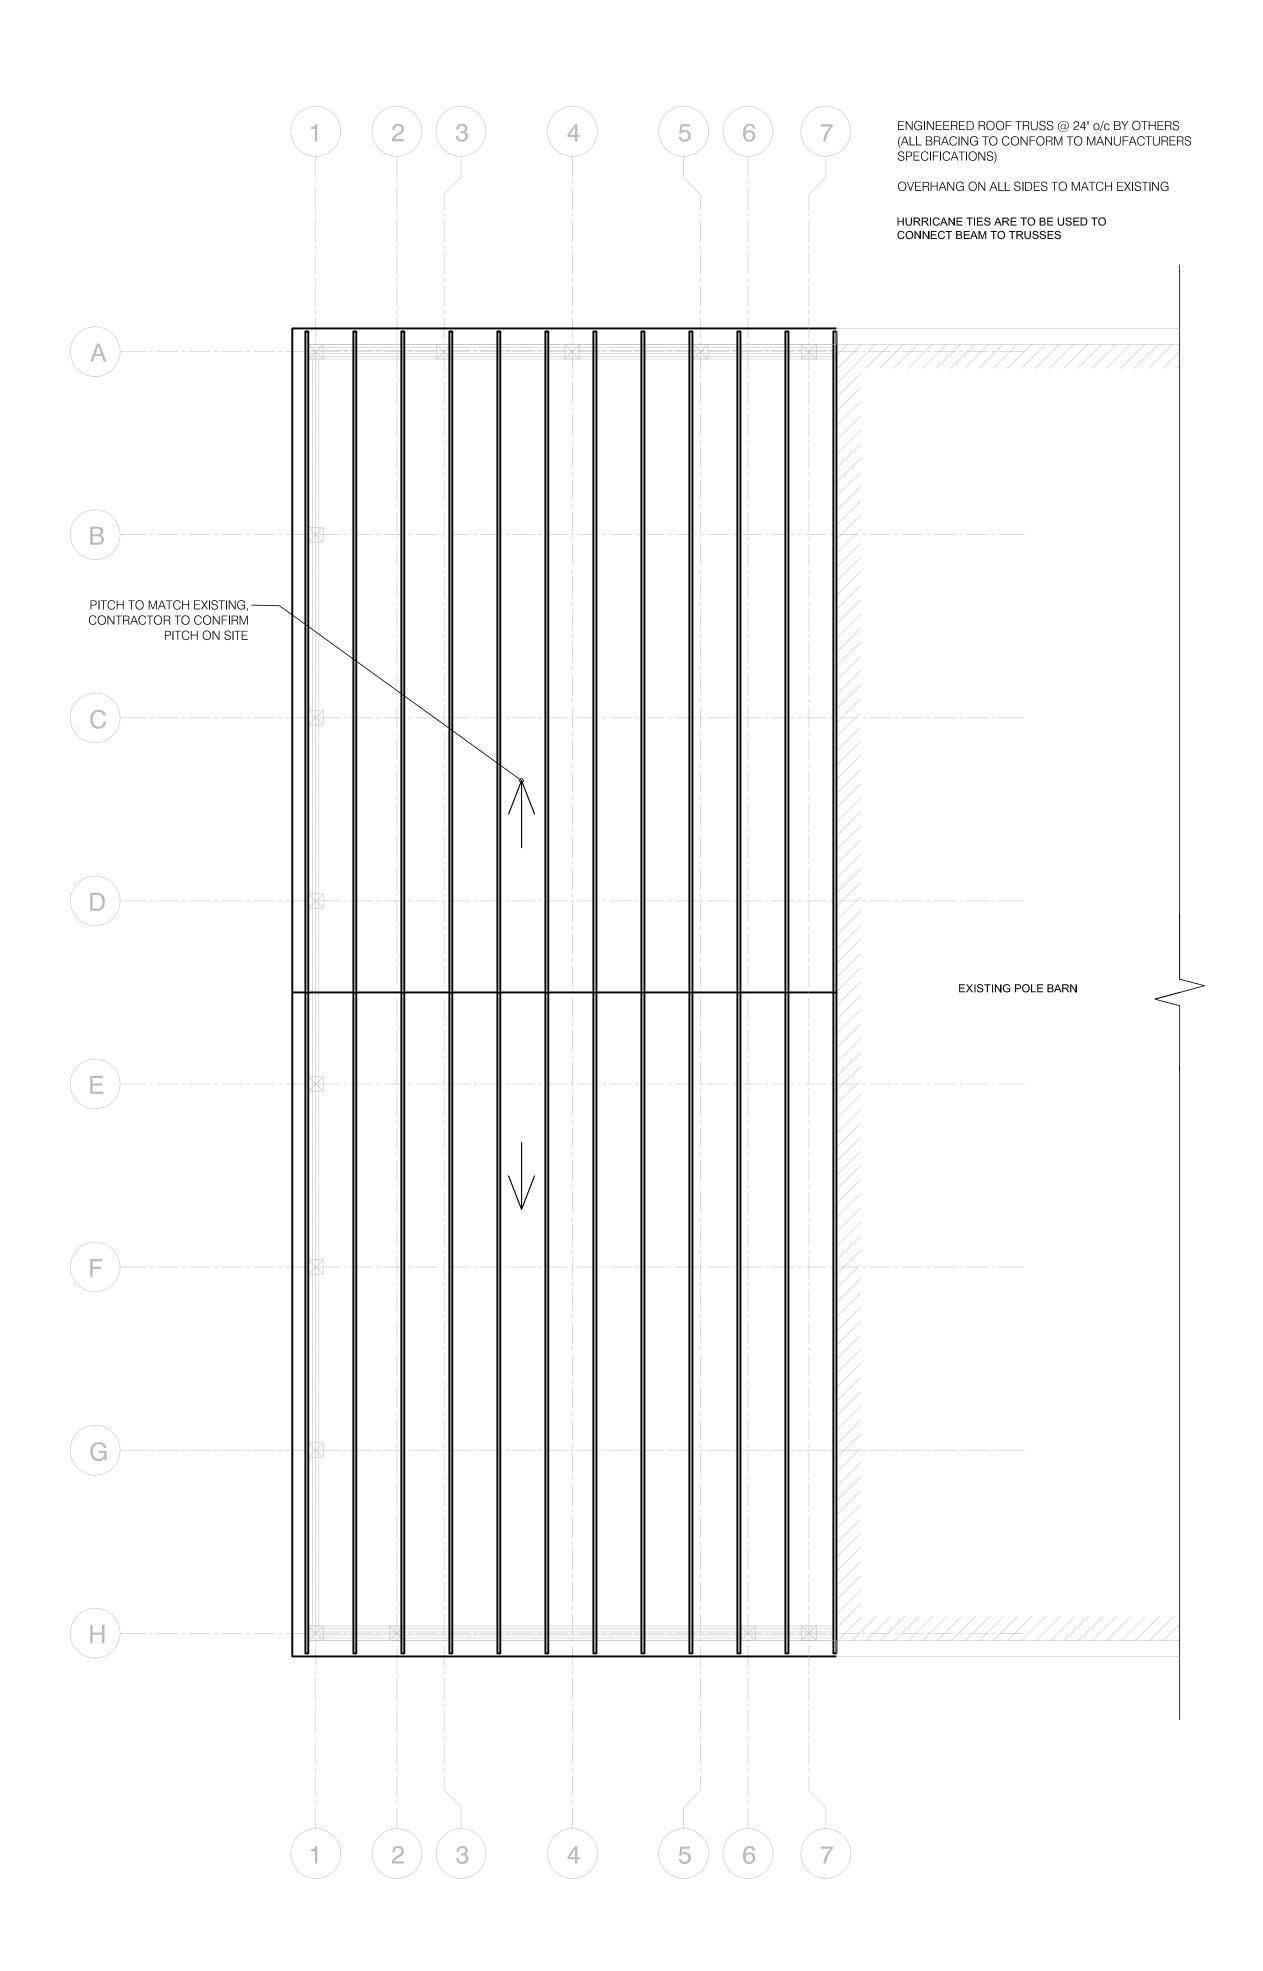
PROPOSED POLE BARN ADDITION

45 Robilard Dr., Penetanguishene ON.

David Wright (Maacon)

Prawing Title
Foundation Plan & Floor Plan

Date:		Project No.	
Od	ct 2021		
Drawn By:	Checked By:	6256	
AB	DWL	6356	5
Scale:	e Plot		



1 ROOF PLAN SCALE: 1/4" = 1'-0"

GENERAL NOTES & REQUIREMENTS:

- 1. CONTRACTOR TO CHECK ALL DIMENSIONS,
 SPECIFICATIONS, ETC. ON SITE, AND SHALL BE
 RESPONSIBLE FOR REPORTING ANY
 DISCREPANCIES TO THE DESIGNER PRIOR TO
 CONSTRUCTION.
- 2. THESE PLANS ARE TO REMAIN THE PROPERTY
 QUANTUM ENGINEERING AND MUST BE RETURNED
 UPON REQUEST. REPRODUCTION OF THESE PLANS
 IS STRICTLY FORBIDDEN WITHOUT QUANTUM'S
 WRITTEN PERMISSION. THESE PLANS MUST NOT
 BE USED IN ANY OTHER LOCATION WITHOUT THE
 WRITTEN APPROVAL OF QUANTUM ENGINEERING.
- 3. OFFICIAL COPIES MUST BEAR AN ORIGINAL SIGNATURE AND SHOW THE ENGINEERS STAMP IN
- THESE DRAWINGS ARE NOT TO BE SCALED.
 IT IS THE RESPONSIBILITY OF THE CONTRACTOR
- TO ENSURE ALL SITE UTILITIES ARE LOCATED PRIOR TO CONSTRUCTION.
- ALL DIMENSIONS ARE TO FRAMING UNLESS OTHERWISE STATED WITHIN THE DRAWINGS.
- 7. DESIGN BASED ON CONCRETE STRENGTH AT 28 DAYS OF:
- 7.1. CONCRETE FOR PIERS, POURED WALLS, FOOTINGS & NON
- STRUCTURAL INTERIOR PADS 3625psi (25MPa)
 7.2. STRUCTURAL SLAB ON GRADE or WALL 4650psi (32 MPa)
- 5-8% AIR ENTRAINMENT, PROTECT ALL
 CONCRETE DURING CURING FROM RAIN &
 FREEZING CONDITIONS.
- 8. REINFORCEMENT BARS TO BE HI-BOND AND HAVE
 A MINIMUM YIELD STRENGTH OF 400MPa. THE BARS
 MUST BE HELD SECURELY FOR THE PLACEMENT
 OF CONCRETE, AND ADDITIONAL SUPPORT BARS
- OF CONCRETE, AND ADDITIONAL SUPPORT BARS
 OR STIRRUPS ARE TO BE USED AS REQUIRED.

 9. CONTINUOUS REINFORCING BARS SHALL BE
 LAPPED / SPLICED AT CORNERS IN CONFORMANCE
 WITH THE REQUIREMENTS OF THE RELEVANT CSA
- DESIGN, UNLESS OTHERWISE NOTED ON THE
 DRAWINGS (40 times the bar diameter minimum).

 10. MINIMUM COVER FOR REINFORCING BARS UNLESS

STANDARDS AND THE TYPICAL DETAILS OF THIS

- OTHERWISE NOTED SHALL BE 3".

 11. THESE DRAWINGS ARE STRUCTURAL ONLY.
 PLUMBING, ELECTRICAL AND ALL OTHER
 MECHANICAL DESIGNS TO BE COMPLETED BY
 OTHER. CONTRACTOR SHALL VERIFY DIMENSIONS
 AND LOCATIONS OF ALL MECHANICAL / PLUMBING /
 ELECTRICAL UTILITIES, SLOTS, PIPE SLEEVES,
 ANCHOR BOLTS, ETC. AS REQUIRED FOR OTHER
 TRADES, PRIOR TO THE PLACEMENT OF
 CONCRETE.
- 12. CONCRETE WORK SHALL COMPLY WITH CSA-A23.1-14 / CSA-A23.2-14 , CSA-A23.3-14 & CSA-A23.4-14
- 13. STRUCTURAL STEEL WORK SHALL COMPLY WITH CSA S16.1-14
- 14. ALL CONSTRUCTION SHALL CONFORM TO THE MOST RECENT ONTARIO BUILDING CODE & ALL OTHER APPLICABLE CODES & BYLAWS IN EFFECT AT THE PROJECT LOCATION.

NOTE TO EARTH WORKS / FOUNDATION INSTALLER(S):

- 1. SOIL CONDITIONS UNDER THE FOOTINGS, SLAB
 ON GRADE AND / OR PADS ARE CRUCIAL AND
 SHOULD CONSIST OF A COMPACTED GRANULAR
 MATERIAL AS PER THE FOUNDATION
 SPECIFICATIONS WITHIN THIS PLAN OR ON
 UNDISTURBED SOIL THAT WILL ALLOW WATER
 TO DRAIN TO A DEPTH BELOW THE EXPECTED
 FROST LINE AND HAS AN ALLOWABLE SOIL
 BEARING CAPACITY OF AT LEAST 1500 psf.
- 2. DUE TO LACK OF A SPECIFIC GEOLOGICAL SURVEY, ASSUMPTIONS WERE MADE DURING THE DESIGN. QUANTUM ENGINEERING IS NOT RESPONSIBLE FOR DIFFERENTIAL SETTLEMENT, SLAB CRACKING, OR OTHER FUTURE DEFECTS RESULTING FROM UNREPORTED OR UNOBSERVED SOIL CONDITIONS.
- 3. ALL DIMENSIONS RELATING TO POINT LOADS,
 PIERS OR PADS ARE TO BE VERIFIED BY
 THE CONTRACTOR AND FOUNDATION INSTALLER
 ON SITE PRIOR TO THE PLACEMENT OF
 CONCRETE. CONTRACTOR TO CONFIRM OVERALL
 LENGTH AND WIDTH DIMENSIONS OF ALL
 FOUNDATION ELEMENTS ON SITE PRIOR TO ANY
 CONSTRUCTION. CONTRACTOR TO CONFIRM
 SLAB FINISH WITH OUR OFFICE PRIOR TO
 CONSTRUCTION.
- 4. CONTROL JOINTS IN SLAB FLOOR SURFACE ARE
 TO BE SPACED EVENLY (10' x 10') OR AS
 INDICATED ON THE PLAN, CUT 1/4" DEEP, 6-18
 HOURS AFTER CONCRETE PLACEMENT.
- 5. ALL ORGANIC MATERIALS MUST BE REMOVED FROM THE FOUNDATION EXCAVATION PRIOR TO CONSTRUCTION AND / OR FOUNDATION BACKFILLING.
- 6. EXCAVATION MUST BE COMPLETELY **VOID OF**WATER BEFORE & DURING CONCRETE

 PLACEMENT. QUANTUM ENGINEERING MUST BE

 CONTACTED FOR INSPECTION IF A DRY

 EXCAVATION CANNOT BE ACHIEVED. ALL

 FOOTINGS AND / OR RIGID INSULATION SHALL BE


 FOUNDED ON NATIVE, UNDISTURBED SOIL OR A

 MAXIMUM 8" FULLY COMPACTED "A" GRAVEL OR

 3/4" CRUSHED STONE, FOR LEVELING PURPOSES

 ONLY

IF REQUIRED BY THE AUTHORITY HAVING
JURISDICTION, OUR OFFICE MUST BE CONTACTED
FOR ANY STEEL, CONCRETE, FORMING OR FRAMING
INSPECTIONS MINIMUM 2 DAYS IN ADVANCE OF THE
PLACEMENT OF CONCRETE OR COVERING
OF STRUCTURAL ELEMENTS

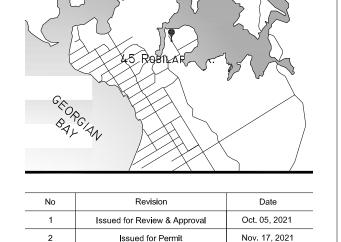

Revised for Permit

Revised for Permit

Nov. 23, 2023 Dec 19, 2023





PROPOSED POLE BARN ADDITION

45 Robilard Dr., Penetanguishene ON.

David Wright (Maacon)


Drawing Title

Roof Plan & Notes

 Date:
 Oct 2021
 Project No.

 Drawn By:
 Checked By:
 6356

 Scale:
 See Plot

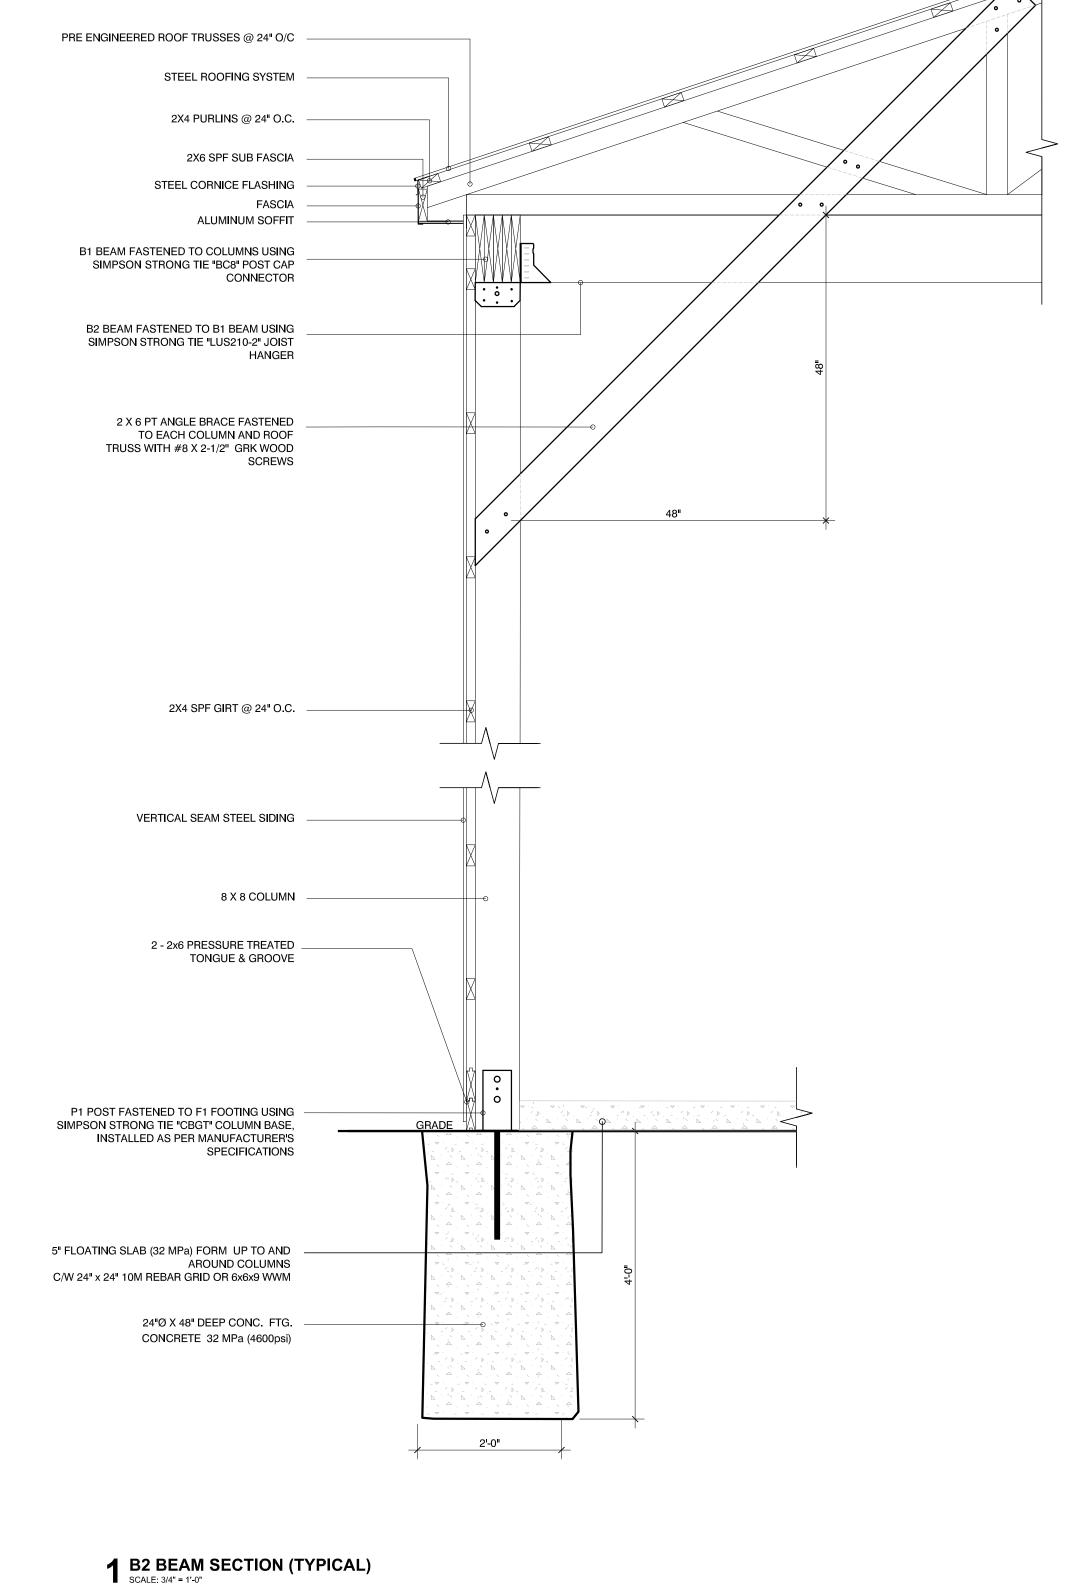


2X4 SPF GIRT @ 24" O.C. _ VERTICAL SEAM STEEL SIDING 8 X 8 COLUMN 2 - 2x6 PRESSURE TREATED TONGUE & GROOVE P1 POST FASTENED TO F1 FOOTING USING SIMPSON STRONG TIE "CBGT" COLUMN BASE, INSTALLED AS PER MANUFACTURER'S SPECIFICATIONS 5" FLOATING SLAB (32 MPa) FORM UP TO AND AROUND COLUMNS C/W 24" x 24" 10M REBAR GRID OR 6x6x9 WWM 24"Ø X 48" DEEP CONC. FTG. CONCRETE 32 MPa (4600psi)

PRE ENGINEERED ROOF TRUSSES @ 24" O/C -


B2 BEAM FASTENED TO COLUMNS USING SIMPSON STRONG TIE "BC48" POST CAP CONNECTOR

> 2 X 6 PT ANGLE BRACE FASTENED TO EACH COLUMN AND BEAM WITH #8 x 2" GRK WOOD SCREWS

2 B1 BEAM SECTION (TYPICAL) SCALE: 3/4" = 1'-0"

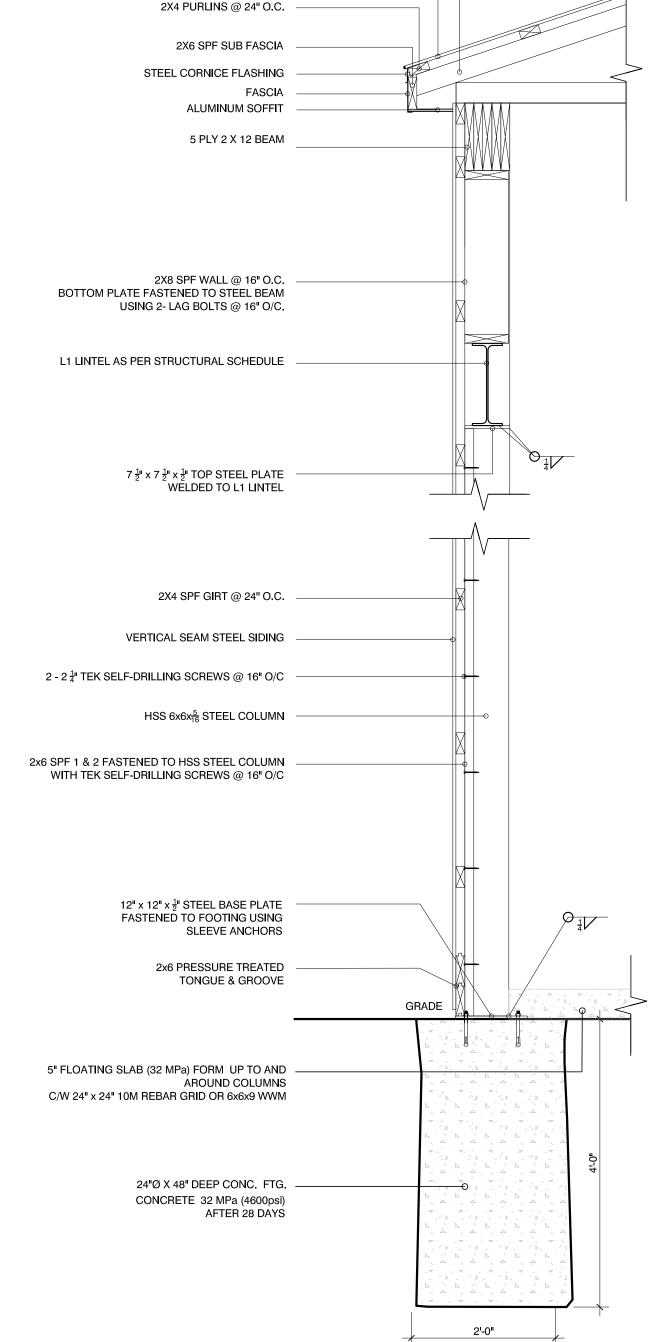



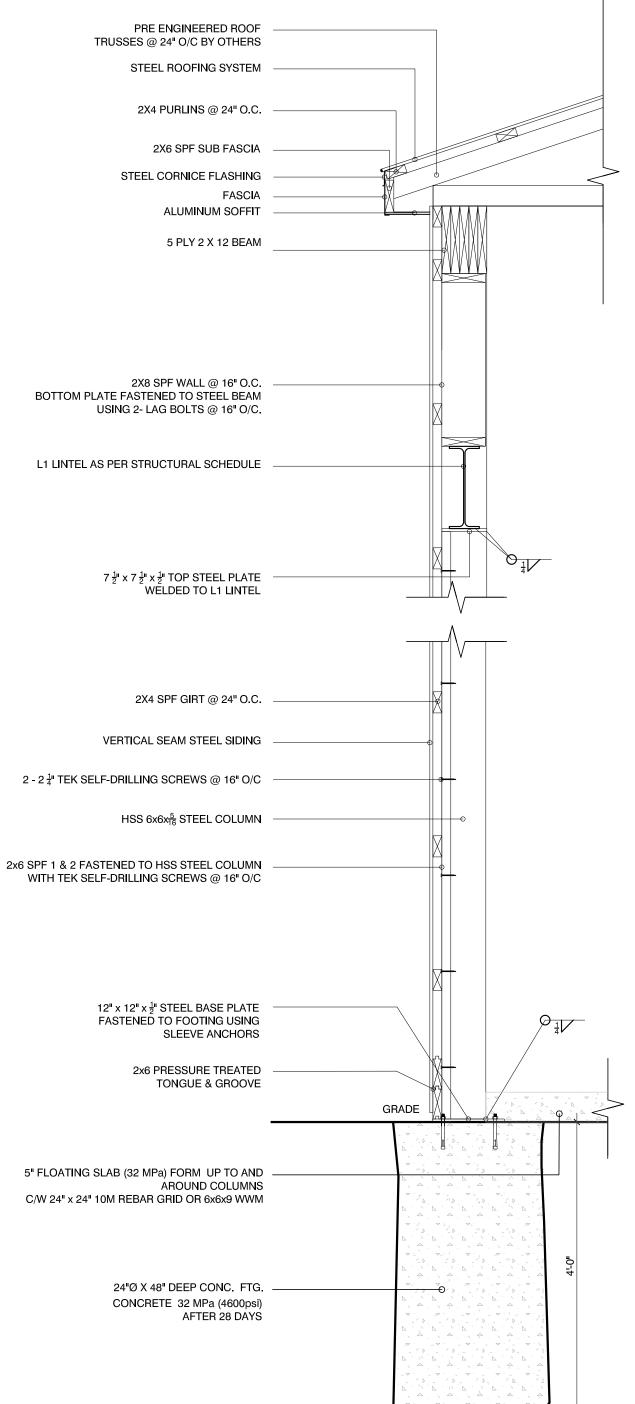

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No	Revision	Date
4	Incomed for Devices 0. Assessed	0-4 05 2024

∀ }	- M	
No	Revision	Date
1	Issued for Review & Approval	Oct. 05, 2021
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3	Revised for Permit	Nov. 23, 2023
4	Revised for Permit	Dec 19, 2023

D. W. LALONDE

2023/12/19

PROPOSED POLE BARN ADDITION

45 Robilard Dr., Penetanguishene ON.

Checked By:

David Wright (Maacon)

Drawing Title

Sections

OUANTUM

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